ABBREVIATIONS

| , . | | | 0 | | 1 1 | |
|--|--|---|---|---|---|--|
| AB ACP ACT ADJ AFF AGG ALT ALUM / AL ANOD AP APPROX AV | Anchor Bolt Acoustic Ceiling Panel Acoustic Ceiling Tile Adjustable Above Finish Floor Aggregate Alternate Aluminum Anodized Access Panel Approximate Audio Visual | | GALV GB / GYP BD GBLK GC GEN GL GL BLK GLU-LAM H | Galvanized Gypsum Board Glazed Block General Contractor General Glass or Glazing Glass Block Glue Laminated Handicapped Hardware | R RAD RB RD REC REF REINF REQD REVF RM RO RP RT RUB | Riser / Radius Radiation Rubber Base Roof Drain Recessed Refrigerator Reinforced or Reinforcing Required Reverse Room Rough Opening Resin Panel Rubber Tile or Tread |
| В | | - | HDWD HGT HM | Hardwood Height Hollow Metal | RWL | Rain Water Leader |
| BM BATT | Bench Mark Batt Insulation | | HORZ HR | Horizontal Hour / Handrail | S | |
| BD BFE BIT | Board Bottom Footing Elevation Bituminous | | HYD HVAC | Hydrant Heating or Venting or A/C | SCHED SD | Schedule Soap Dispenser |
| BLDG BLK | Building Block | | ı | | SEAL SECT SF | Sealed Concrete Section Special Finish |
| BLKG BM | Blocking Beam | | ID | Inside Diameter | SGFT SIM | Structural Glazed Facing Tile Similar |
| BOTT BR | Bottom Brick | | IG IGT | Insulated Glass insulated Glass Tempered | SLNT SLR | Sealant Sealer |
| BRG BUR | Bearing Buit-Up Roof | | INT INSUL | Interior Insulation | SLW SND | Slatwall Sanitary Napking Disposal |
| С | | | INV IRGB | Invert Impact Resistant Gypsum Board | SPEC SQ | Specification Square |
| CAB CB | Cabinet Catch Basin | | | | SQFT SRF SST | Square Foot / Feet Seamless Resilient Floor Section Stainless Steel |
| CB CHBD CBD | Chalk Board Cementitious Board | | J | | ST STD | Stain Stain Standard |
| CEM CFG | Cement Clear Float Glass | | JAN JBE JST | Janitor Joist Bearing Elevation Joist | STL STOR | Steel Storage |
| CFM CG | Cubic Feet Per Minute Corner Guard | | JT JT | Joint | SUSP SW | Suspended Switch |
| CI CIP | Cast Iron Cast In Place | | K | | SYM | Symmetry / Symmetrical |
| CJ CL | Control Joint Center Line | | KO | Knock Out | T | |
| CLG CLO CMU | Ceiling Closet Concrete Masonry Unit | | | | T&G | Tongue and Groove |
| CO CONC | Cleanout Concrete | | L LAB | Laboratory | TB TDB | Towel Board Tackboard |
| CONF CONT | Conference Continuous | | LAB LAM LAV | Laboratory Laminated Lavatory | TEL TEMP | Telephone Temporary |
| COL CONC BLK | Column Concrete Block | | LF LLH | Lineal Foot Long Leg Horizontal | TERR TFE TFG | Terrazzo Top of Footing Elevation Tempered Float Glass |
| CONST CORR CP | Construction Corridor Cement Plaster | | LLV LSE | Long Leg Vertical Lawal Scott Erickson | TOM TOS | Top of Masonry Top of Steel |
| CPT CSMU | Carpet Calcium Silicate Masonry Unit | | LWCB | Lightweight Concrete Block | TOW TPH | Top of Wall Toilet Paper Holder |
| CSWK CT | Casework Ceramic Tile | | M | | TPW TR | Toilet Partition Wall Trim |
| CUH CW | Cabinet Unit Heater Curtain Wall | | MACH MAF MAS | Machine Modular Athletic Floor Masonry | TYP TV | Typical Television |
| D | | - | MAT MAX | Material Maximum | U | |
| DEPT DEMO | Department Demolition | | MBD MCC | Marker Board Multi-Color Coating | UH | Unit Heater |
| DF DIA | Drinking Fountain Diameter | | MECH MEMB | Mechanical Membrane | UNFIN UNO | Unfinished Unless Noted Otherwise |
| DIM DKG DN | Dimension Decking Down | | MET MEZZ MFR | Metal Mezzanine Manufacturer | UPW UR | Urinal Partition Wall Urinal |
| DR DS | Door Downspout | | MIN MISC | Minimum or Minutes Miscellaneous | UV | Unit Ventilator |
| DWLS DWG | Dowels Drawing | | MO MR | Masonry Opening Mirror | | |
| E | | | MUL N | Mullion | V | |
| EA | Each | | N | North | VB | Vinyl Base |
| EDC EFIS | Elastrometric Deck Coating Exterior Finished Insulation | | NIC NOM | Not In Contract Nominal | VCT VDBD | Vinyl Composition Tile Visual Display Board |
| System EHD | Electric Hand Dryer | | NO NTS | Number Not To Scale | VERT VEST | Vertical Vestibule |
| EJ ELEC ELEV | Expansion joint Electric Elevation or Elevator | | 0 | | VP VP-SF VRB | Veneer Plaster - Smooth Finish Veneer Plastic - Sand Float Finish Vented Rubber Base |
| EM ENT | Existing Material Entrance | | OA OC | Overall On Center | VWC | Vinyl Wall Covering |
| EQ EQUIP | Equal Equipment | | OD OFF | Outside Diameter Office | | |
| EWC | Each Way Electric Water Cooler | | OHDR OPG | Overhead Door Opening | | |
| EXIST EXP EXT | Existing Exposed Exterior | | OPP | Opposite | | |
| F | LAMINI | | Р | | W | |
| FBC FBR | Fire Blanket / Cabinet Face Brick | | P/C PC-TERR Pre-Cast | Precast Concrete | WC WCV | Water Closet Wall Covering Vinyl |
| FD FDN | Floor Drain Foundation | | PERF PF | Perforated Prefinished | WCP WD | Wall Covering Paper Wood |
| FE FEC | Fire Extinguisher Fire Extinguisher Cabinet | | PL PLAM | Plate Plastic Laminate | WDPNL WDV | Wood Panel Wood Veneer |
| FF FFE | Factory Finish Finished Floor Elevation | | PLAS PLBG | Plaster Plumbing | WF WG | Wash Fountain Wire Glass |
| FG FIN FIXT | Fire Glass Finish | | PLYWD PNL | Plywood Panel or Paneling | WGT WH | Weight Water Heater |
| FIXT FLR FND | Fixture Floor Feminine Napkin Disposal | | PPT PROJ PROP | Porcelain Paver Tile Projection Property | WP WRGB WWF | Waterproofing Water Resistant Gypsum Board Welded Wire Fabric |
| FNDISP FO | Feminine Napkin Dispenser Face Of | | PT PTD | Paint Paper Towel Dispenser | | |
| FR FRM | Fire Rated Frame | | PTDR | Paper Towel Dispenser/Receptor | | |
| FRMG FRP FT | Framing Fiberglass Reinforced Paneling Foot or Feet | | Q | | Z | |
| FTG FURR | Foot of Feet Footing Furring | | QT | Quarry Tile | 'Z' | Zee Channel |
| | - | | | | | |

| DRAWING SYMBOLS | | | | | | |
|---|----------|----------------------------|--|--|--|--|
| (00) KEYNOTES | 100A | DOOR# | | | | |
| 00 WINDOW SHADE | (W10) | WINDOW | | | | |
| F1 FLOOR TAG | (SF-10) | STOREFRONT | | | | |
| W1 6" EXT WALL TAG | ©W-10 | CURTAIN WALL | | | | |
| R1 ROOF TAG | (LV10) | LOUVER | | | | |
| FINISHED FLOOR ELEVATION | (A 4) | MARKER BOARD | | | | |
| ROOM ROOM NAME/ A100 NUMBER | CPT-0 | MATERIAL ID | | | | |
| A MATCH LINE | GRID | —NEW GRID | | | | |
| BUILDING SECTION | GRID | — EXISTING GRID | | | | |
| BUILDING / INTERIOR ELEVATION | <u>_</u> | FLOOR FINISH TRANSITION | | | | |
| 3 A301 FRAME ELEVATION | | BREAK LINE | | | | |
| DETAIL # NAME A201 SCALE SHEET # | NORTH | NORTH ARROW | | | | |
| WALL TYPE ADDITIONAL INFORMATION ACOUSTICAL | | REVISION CLOUD | | | | |

LLBO HALFWAY HOUSE

PROJECT TEAM

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SHEET INDEX


SHEET INDEX - ARCHITECTURAL

MATERIAL ID

LEVEL 1 OVERALL DEMOLITION FLOOR PLAN LEVEL 2 OVERALL DEMOLITION FLOOR PLAN LEVEL 1 OVERALL FLOOR PLAN LEVEL 2 OVERALL FLOOR PLAN **ENLARGED PLANS** ENLARGED PLANS CONT. & INTERIOR ELEVATIONS ENLARGED CEILING PLANS LEVEL 1 FINISH FLOOR PLAN

LEVEL 2 FINISH FLOOR PLAN

SITE VICINITY MAP

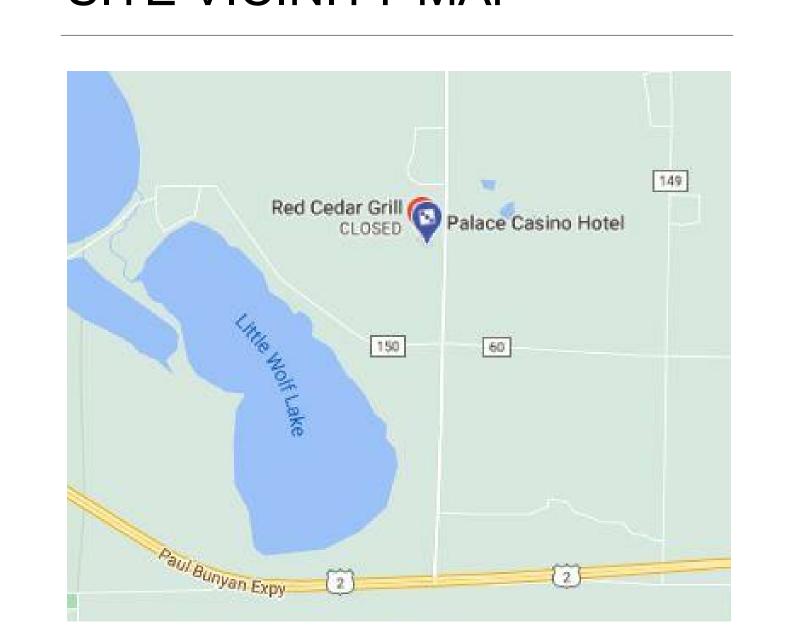



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LLBO Halfway House

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| | | V | | |
|--|---------------|---------|------------|-------------|
| | Date: | 4.15.21 | License #: | 23884 |
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CONSTRUCTION DOCUMENTS

TITLE SHEET

1 LEVEL 1 CODE PLAN
1" = 20'-0"

D. ALLOWABLE HEIGHTS AND BUILDING AREA [Table 503, Sections 506.1, 506.3] **Institution** ALLOWABLE AREA: [Table 503) TYPE V-A I-1-SM = 31,500 s.f.Existing = 23,257 Level 1 18,856 Level 2 ALLOWABLE HEIGHT: [Table 503) TYPE V-A I-1 = 3 Stories Existing 2 Stories E. FIRE RESISTIVE REQUIREMENTS BY TYPE OF CONSTRUCTION Institution CONSTRUCTION TYPE: V-A CONDITION REQUIREMENT NOTES 1. STRUCTURAL FRAME 2. BEARING WALLS-EXTERIOR f = not less than the fire-resistance rating based on fire separation 3. BEARING WALLS-INTERIOR distance (see Table 602) 4. NONBEARING WALLS-EXTERIOR g = Not less than the fire-resistance rating as reference in 5. NONBEARING WALLS-INTERIOR Section 704.10 6. FLOOR CONSTRUCTION 7. ROOF CONSTRUCTION F. Fire Rated Construction FIRE BARRIERS [Fire Resistant Rating Section 707] Fire Barriers shall have a fire-resisitance rating of not less than 1 hour FIRE PARTITIONS [Fire Resistant Rating Section 708.3, Exception 1] Fire Partitions shall have a fire-resisitance rating of not less than 1 hour HORIZONTAL ASSEMBLIES [Section 711.3 Fire Resistance Rating] Horizontal assemblies separating sleeping units in the same building shall be a minimum of **1-hour** fire-resistance-rated construction. [Section 713.4 Fire Resistance Rating] SHAFT ENCLOSURES Shaft enclosures shall have a *fire-resistance rating* of not less than **1 hour** where connecting lsess than four stories Shaft enclosures shall be constructed as Fire Barriers. **OPENINGS** Opening Fire Protection Assemblies in hours [Table 716.5] 1 hr Shaft Enclosure = **1 hour** fire door assembly 100 sq. in. vision panel allowed 1 hr Fire Barrier = minimum 3/4 hour fire door assembly Maximum tested glazing size allowed 1 hr Fire Partitions = 1/3 hour fire door assembly 1/2 hr Fire Partitions = 1/3 hour fire door assembly Maximum test glazing size allowed G. Automatic Sprinkler Systems An automatic sprinkler system shall be provided throughout stories containing Group A-2 occupancies and throughout all stories from the Group A-2 occupancy to and including the levels of exit discharge serving that occupancy where one of the following conditions exists: 1. The fire area exceeds 5,000 square feet. [903.2.6 Group I] An automatic sprinkler system shall be provided throughout buildings with a Group I fire area.

An automatic sprinkler system installed in accordance with Section 903.3.1.2 shall be permitted in Group I-1, Condition 1 facilities.

Exceptions

H. OCCUPANT LOAD AND EXITING REQUIREMENTS [Table 1004.5, Table 1006.3.2] A-2 B S Occ. | Occ. | Total Occ | Reg'd I. MEANS OF EGRESS [Means of Egress Sizing 1005.3.1, 1005.3.2] REQ'D PROVIDED LOAD EXIT WIDTH * EXIT WIDTH (inches per occ = 0.2) 77.8 Level 1 - total 389 202 40.4 Level 2 - total OCC. REQ'D PROVIDED <u>LOAD</u> EXIT WIDTH EXIT WIDTH * (inches per occ = 0.3) 60.6 COMMON PATH [Table 1006.2.1] The common path of egress travel shall not exceed 75' EXIT ACCESS TRAVEL DISTANCE: [Table 1017.2] <u>OCCUPANCY</u> ALLOWABLE * ACTUAL MAX. *250' with sprinkler system 135' *250' with sprinkler system *300' with sprinkler system J. ACCESSIBILITY Accessible Dwelling Units and Sleeping Units nimum Required Number of Accessible Units Without Accessible Units With Roll-In Showers Total Provided 51 to 75

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Printed Name: Quintin J. Scott, AIA

Signature: Q. 4. | Aut

o. Date Revision Descripti

CONSTRUCTION DOCUMENTS

CODE ANALYSIS/EXITING PLAN

 Project
 20.1025.01
 Drawing Number

 Date
 1.15.21

 Drawn by
 BMW


 Checked by
 RJ

Drawn by BMW
Checked by RJ

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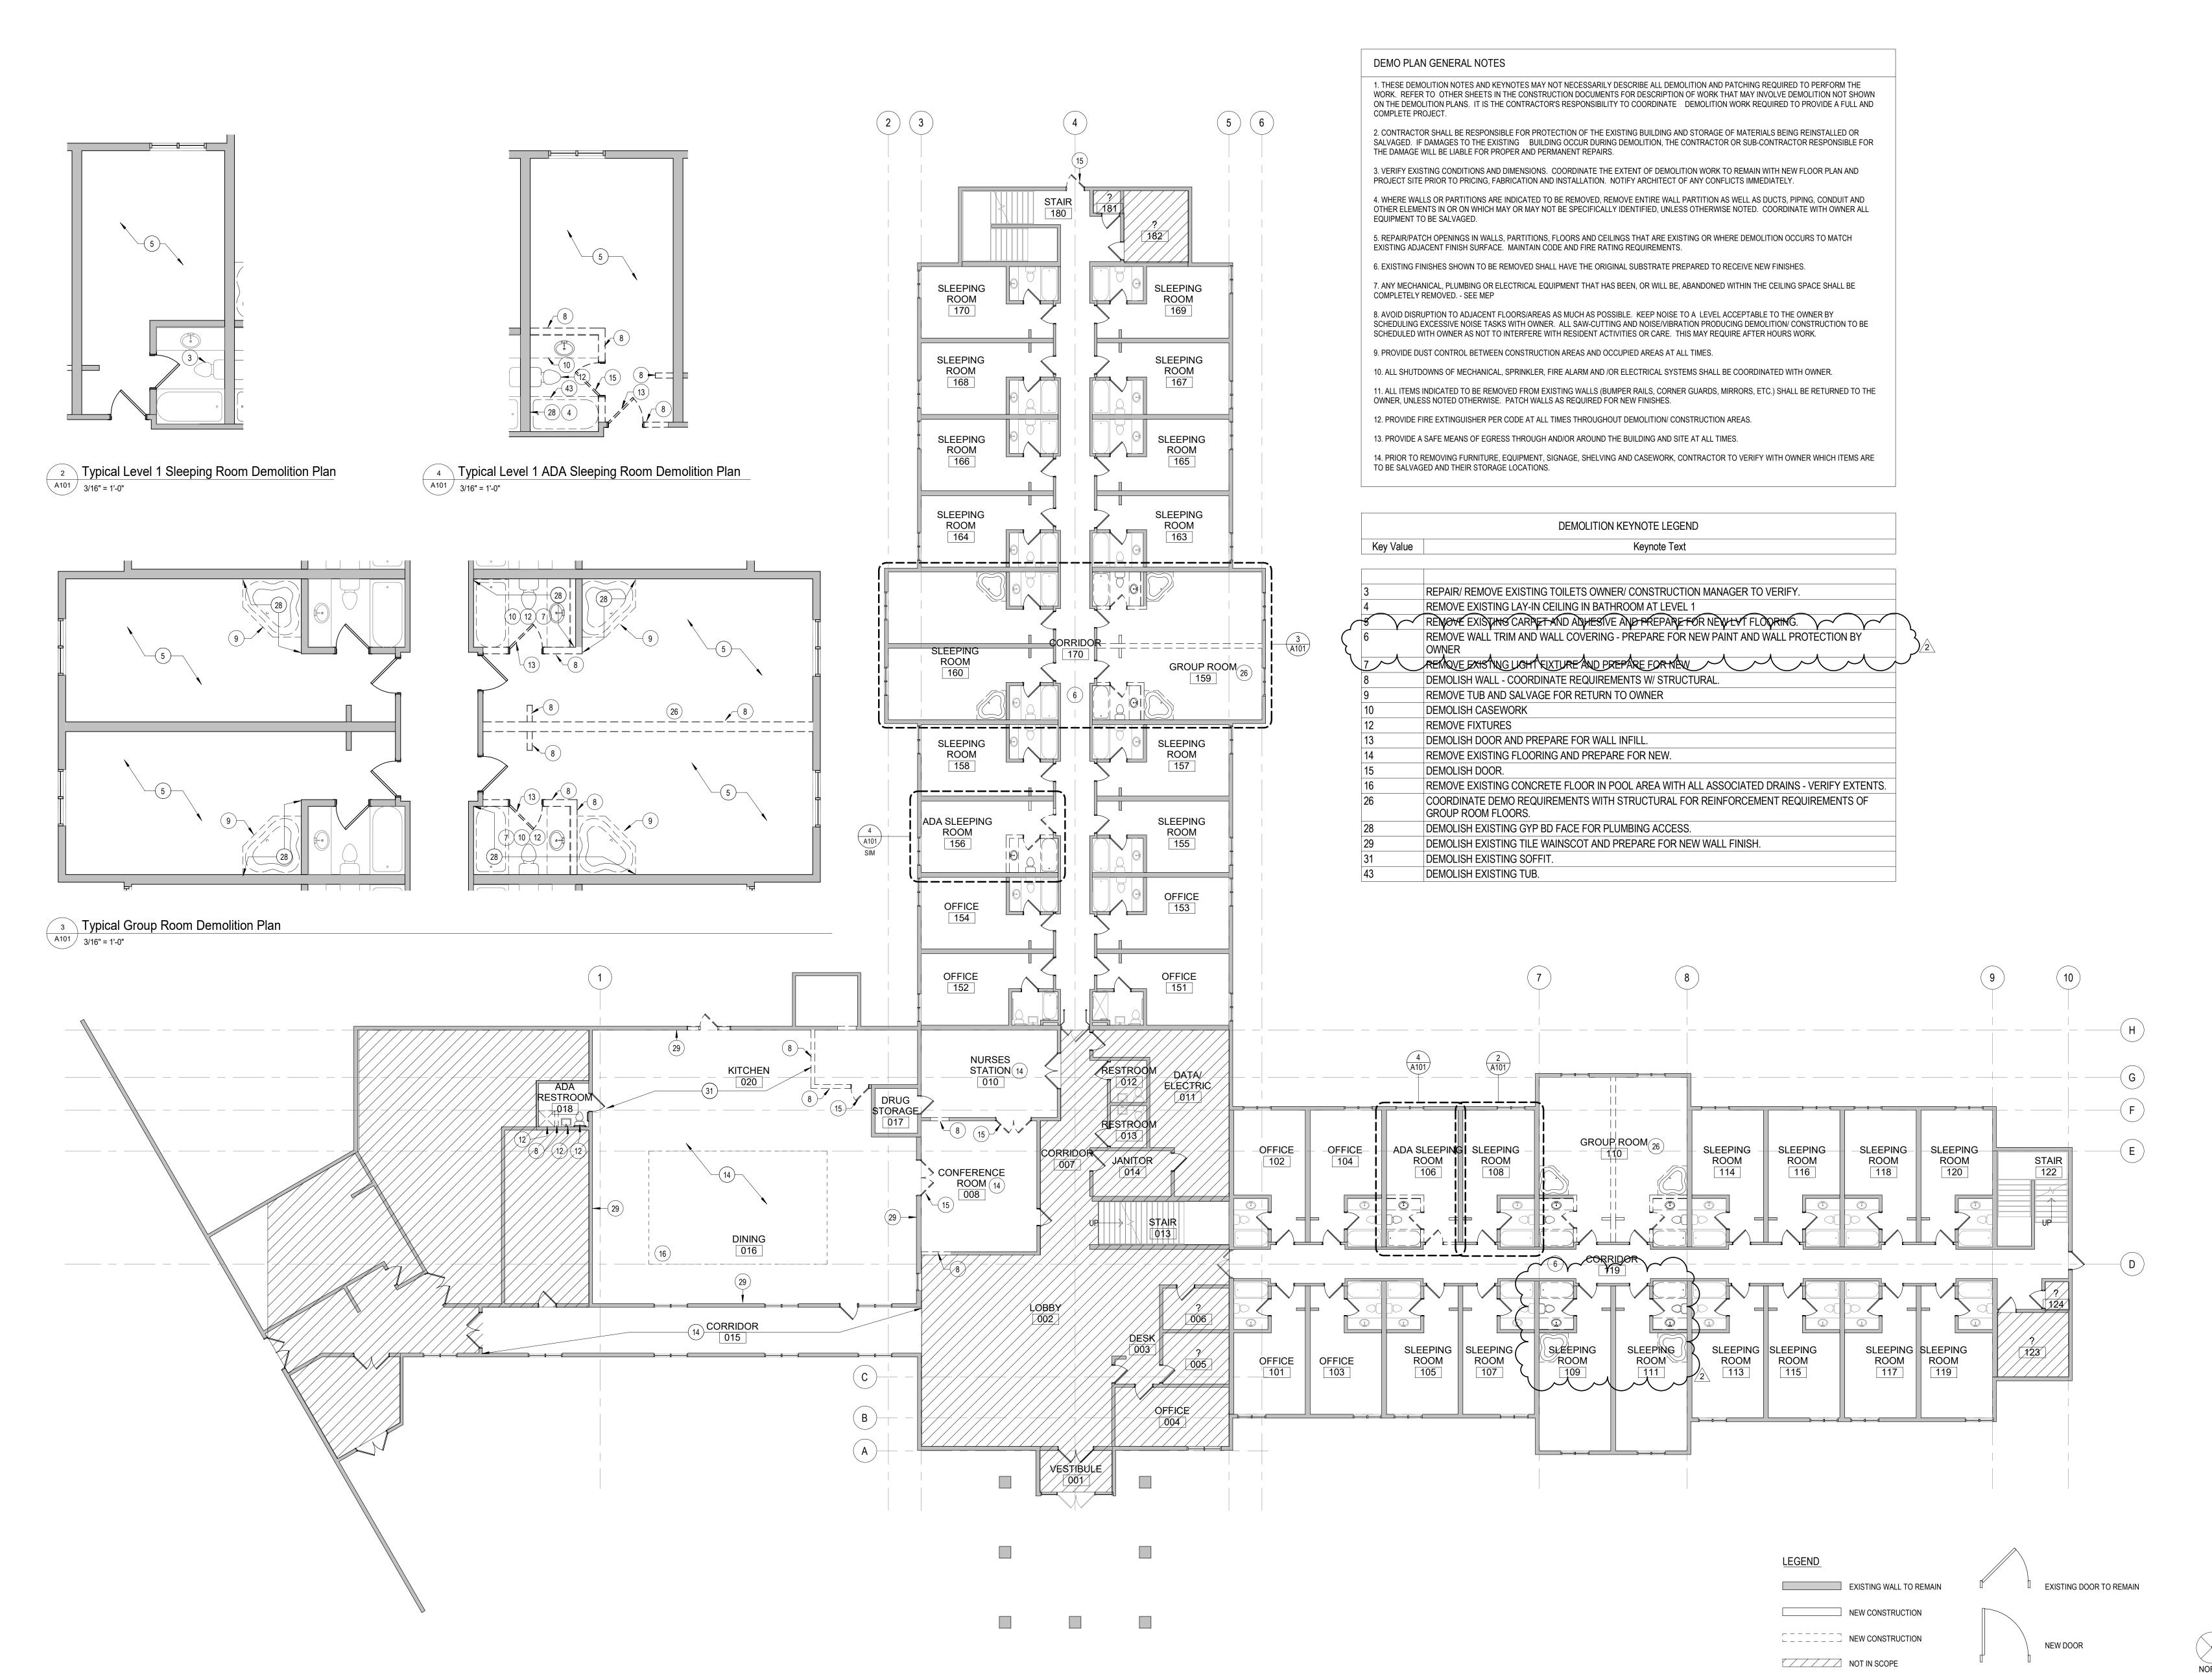
—1-HR—1-HR— 1-HR RATED FIRE PARTITION - INTERIOR BEARING WALL

AND DEMISING WALL - 20-MIN RATED OPENINGS

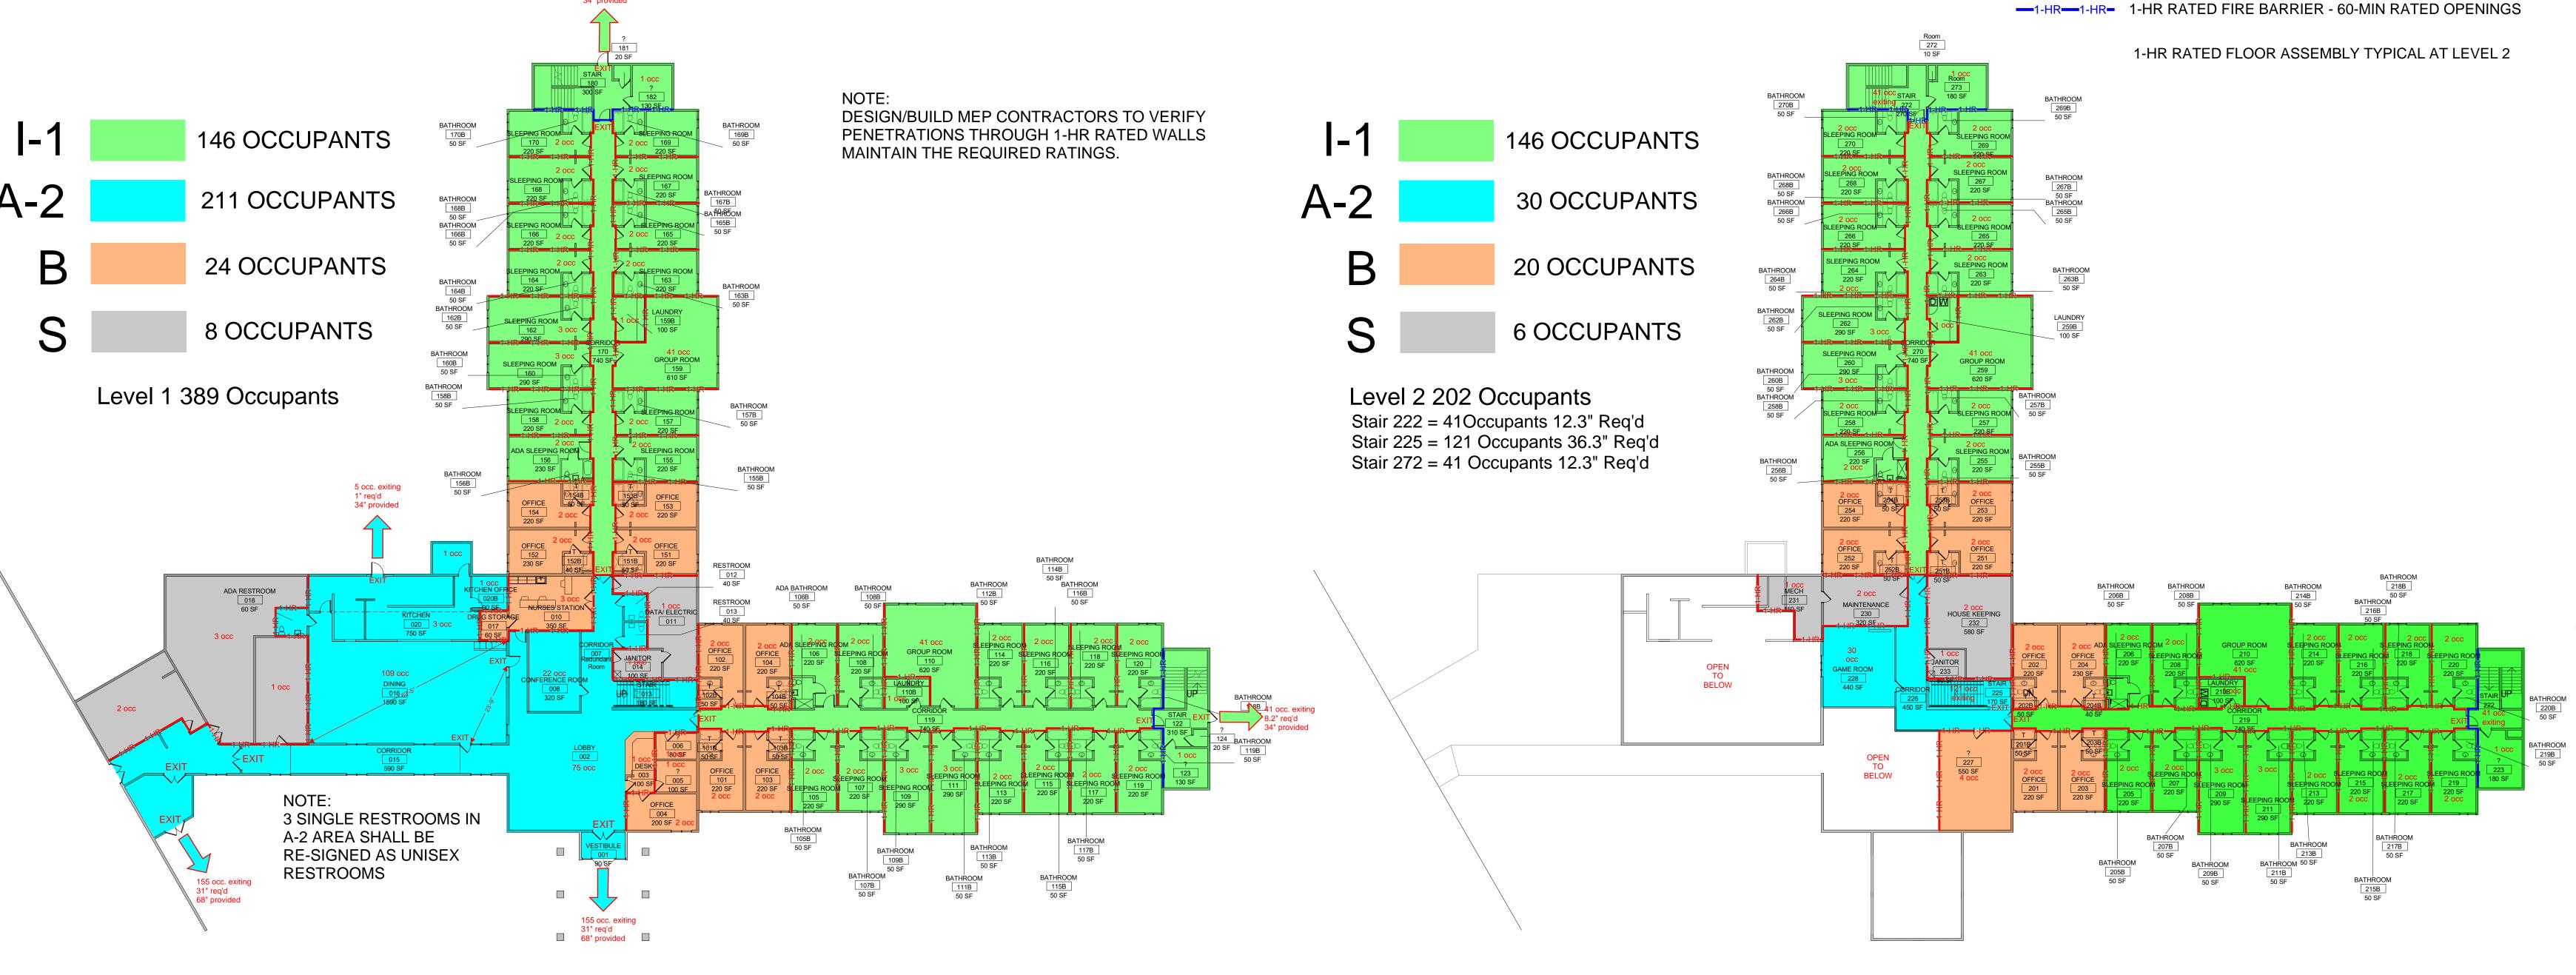

2 LEVEL 2 CODE PLAN

R101 1" = 20'-0"



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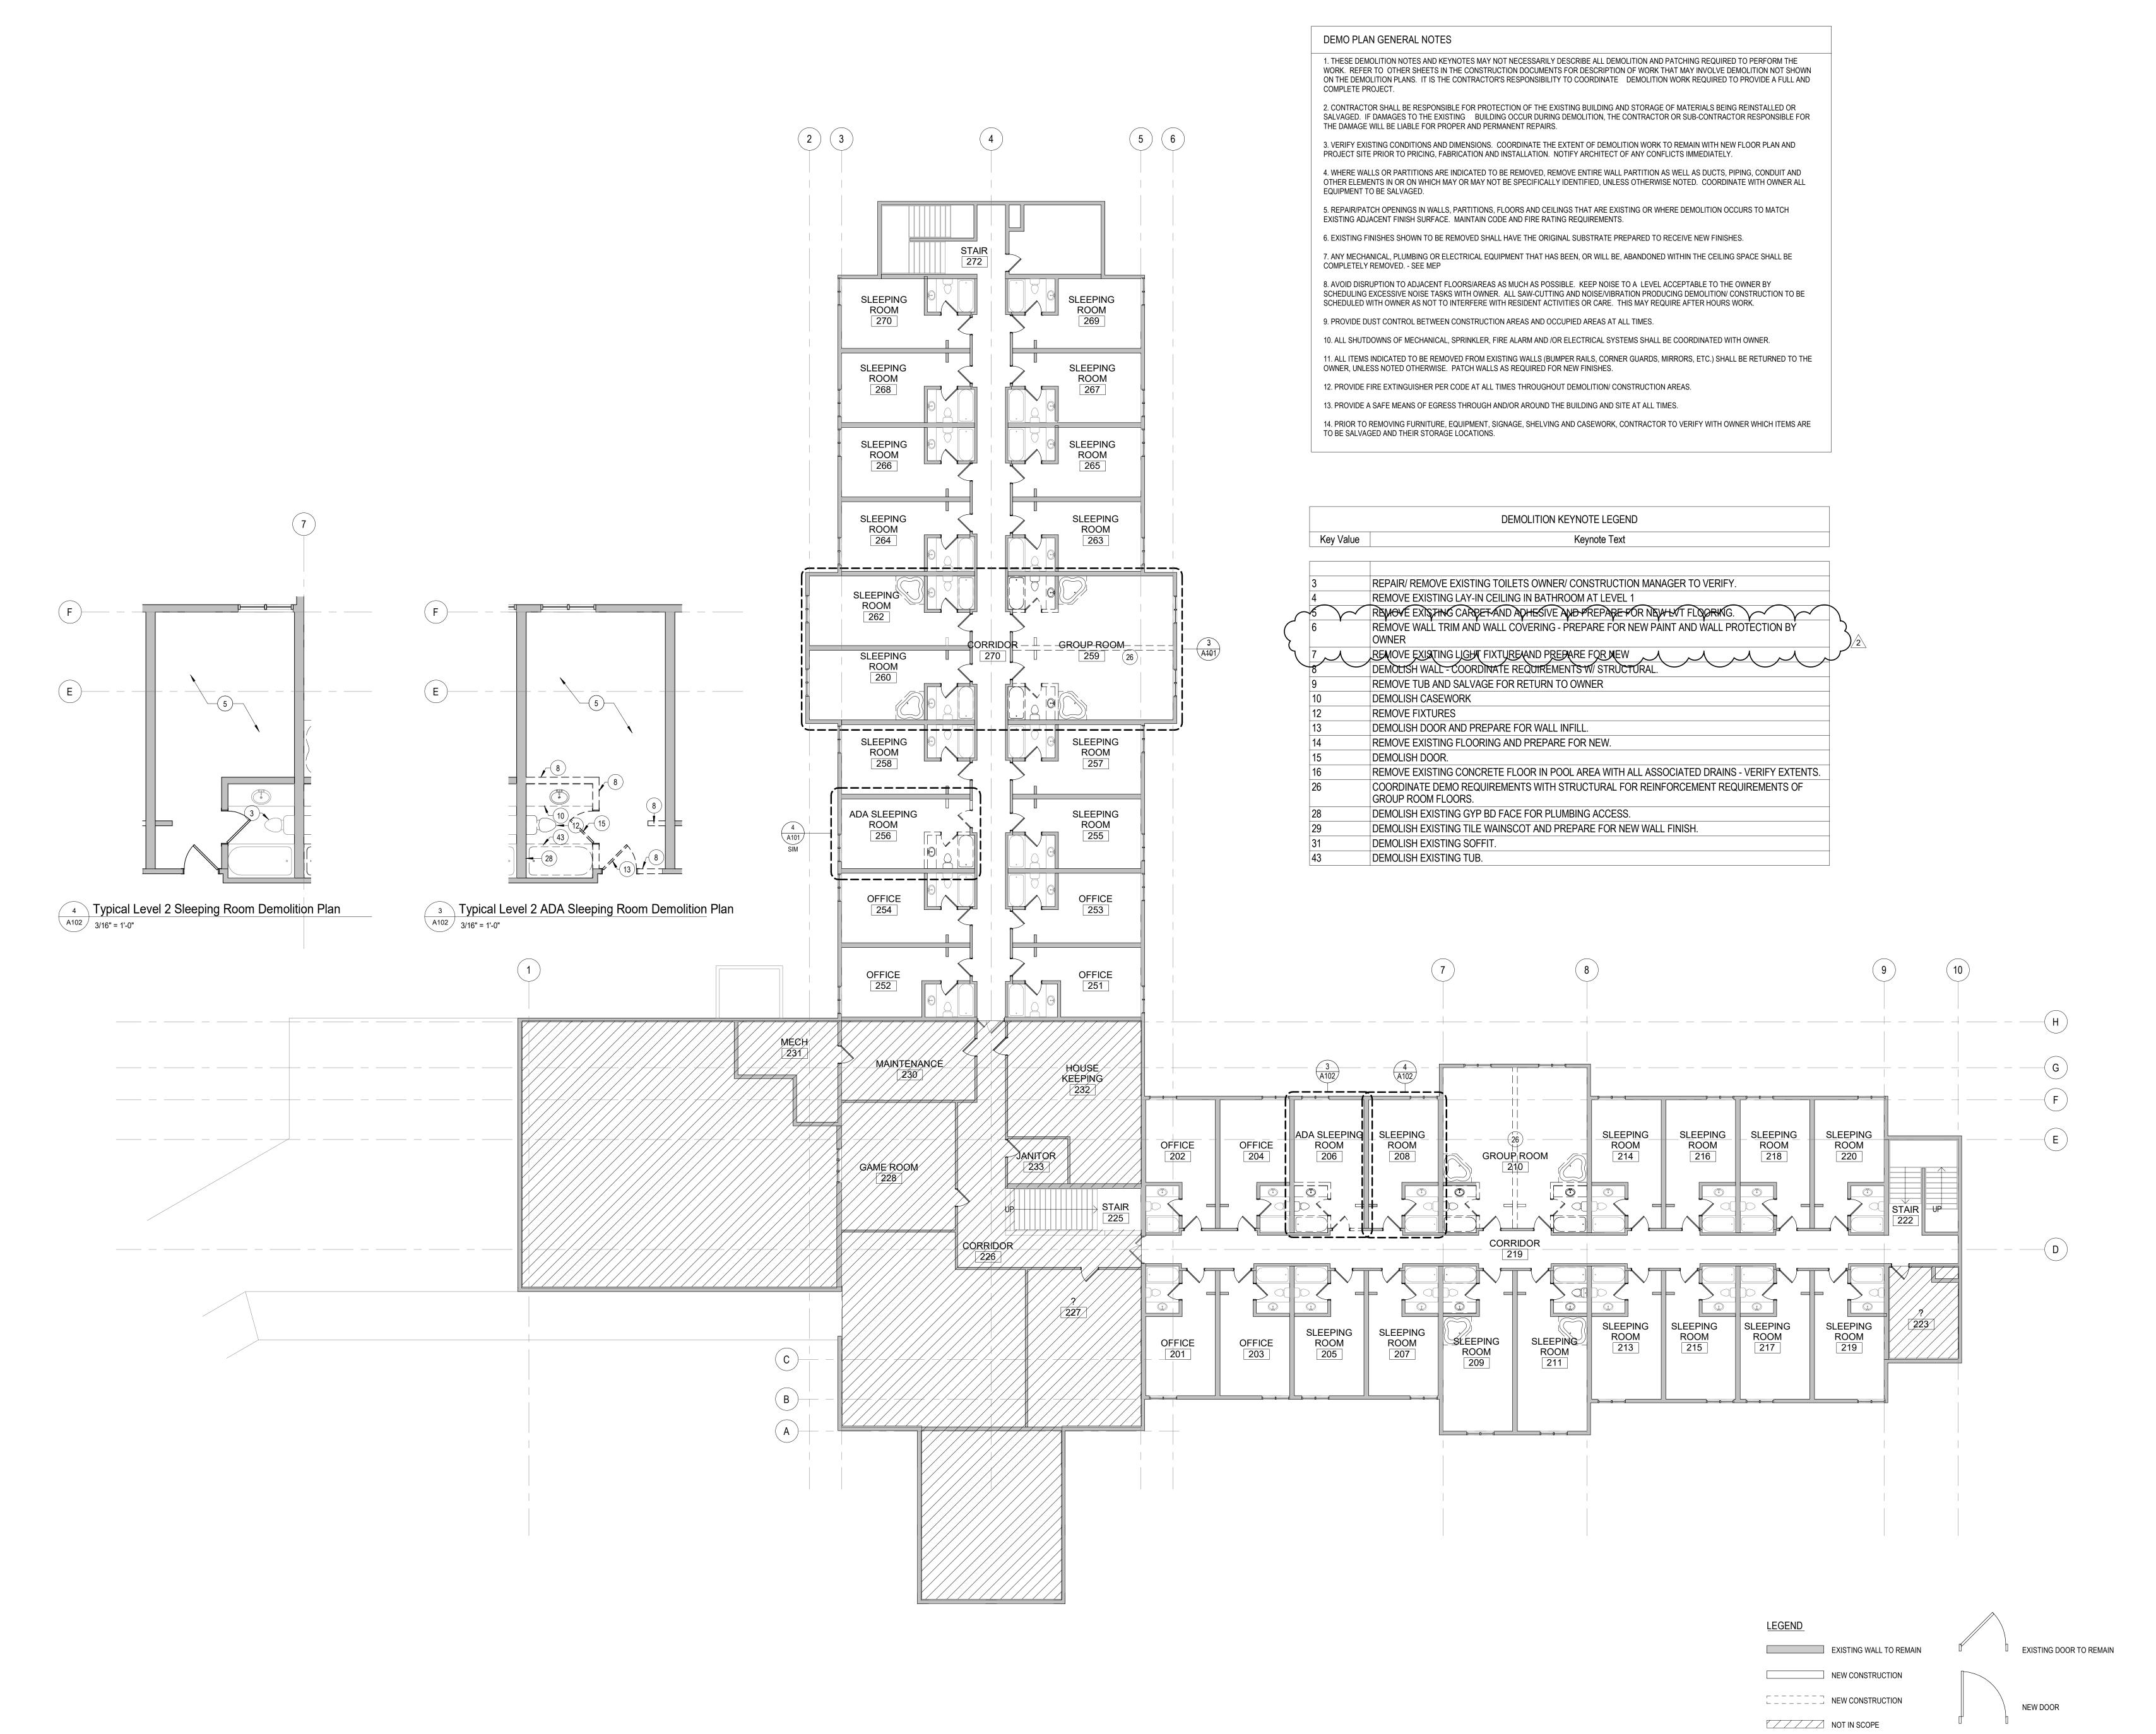
LEVEL 1 OVERALL DEMOLITION FLOOR PLAN

 Project
 20.1025.01
 Drawing Number

 Date
 1.15.21

 Drawn by
 MMD

 Checked by
 RJ



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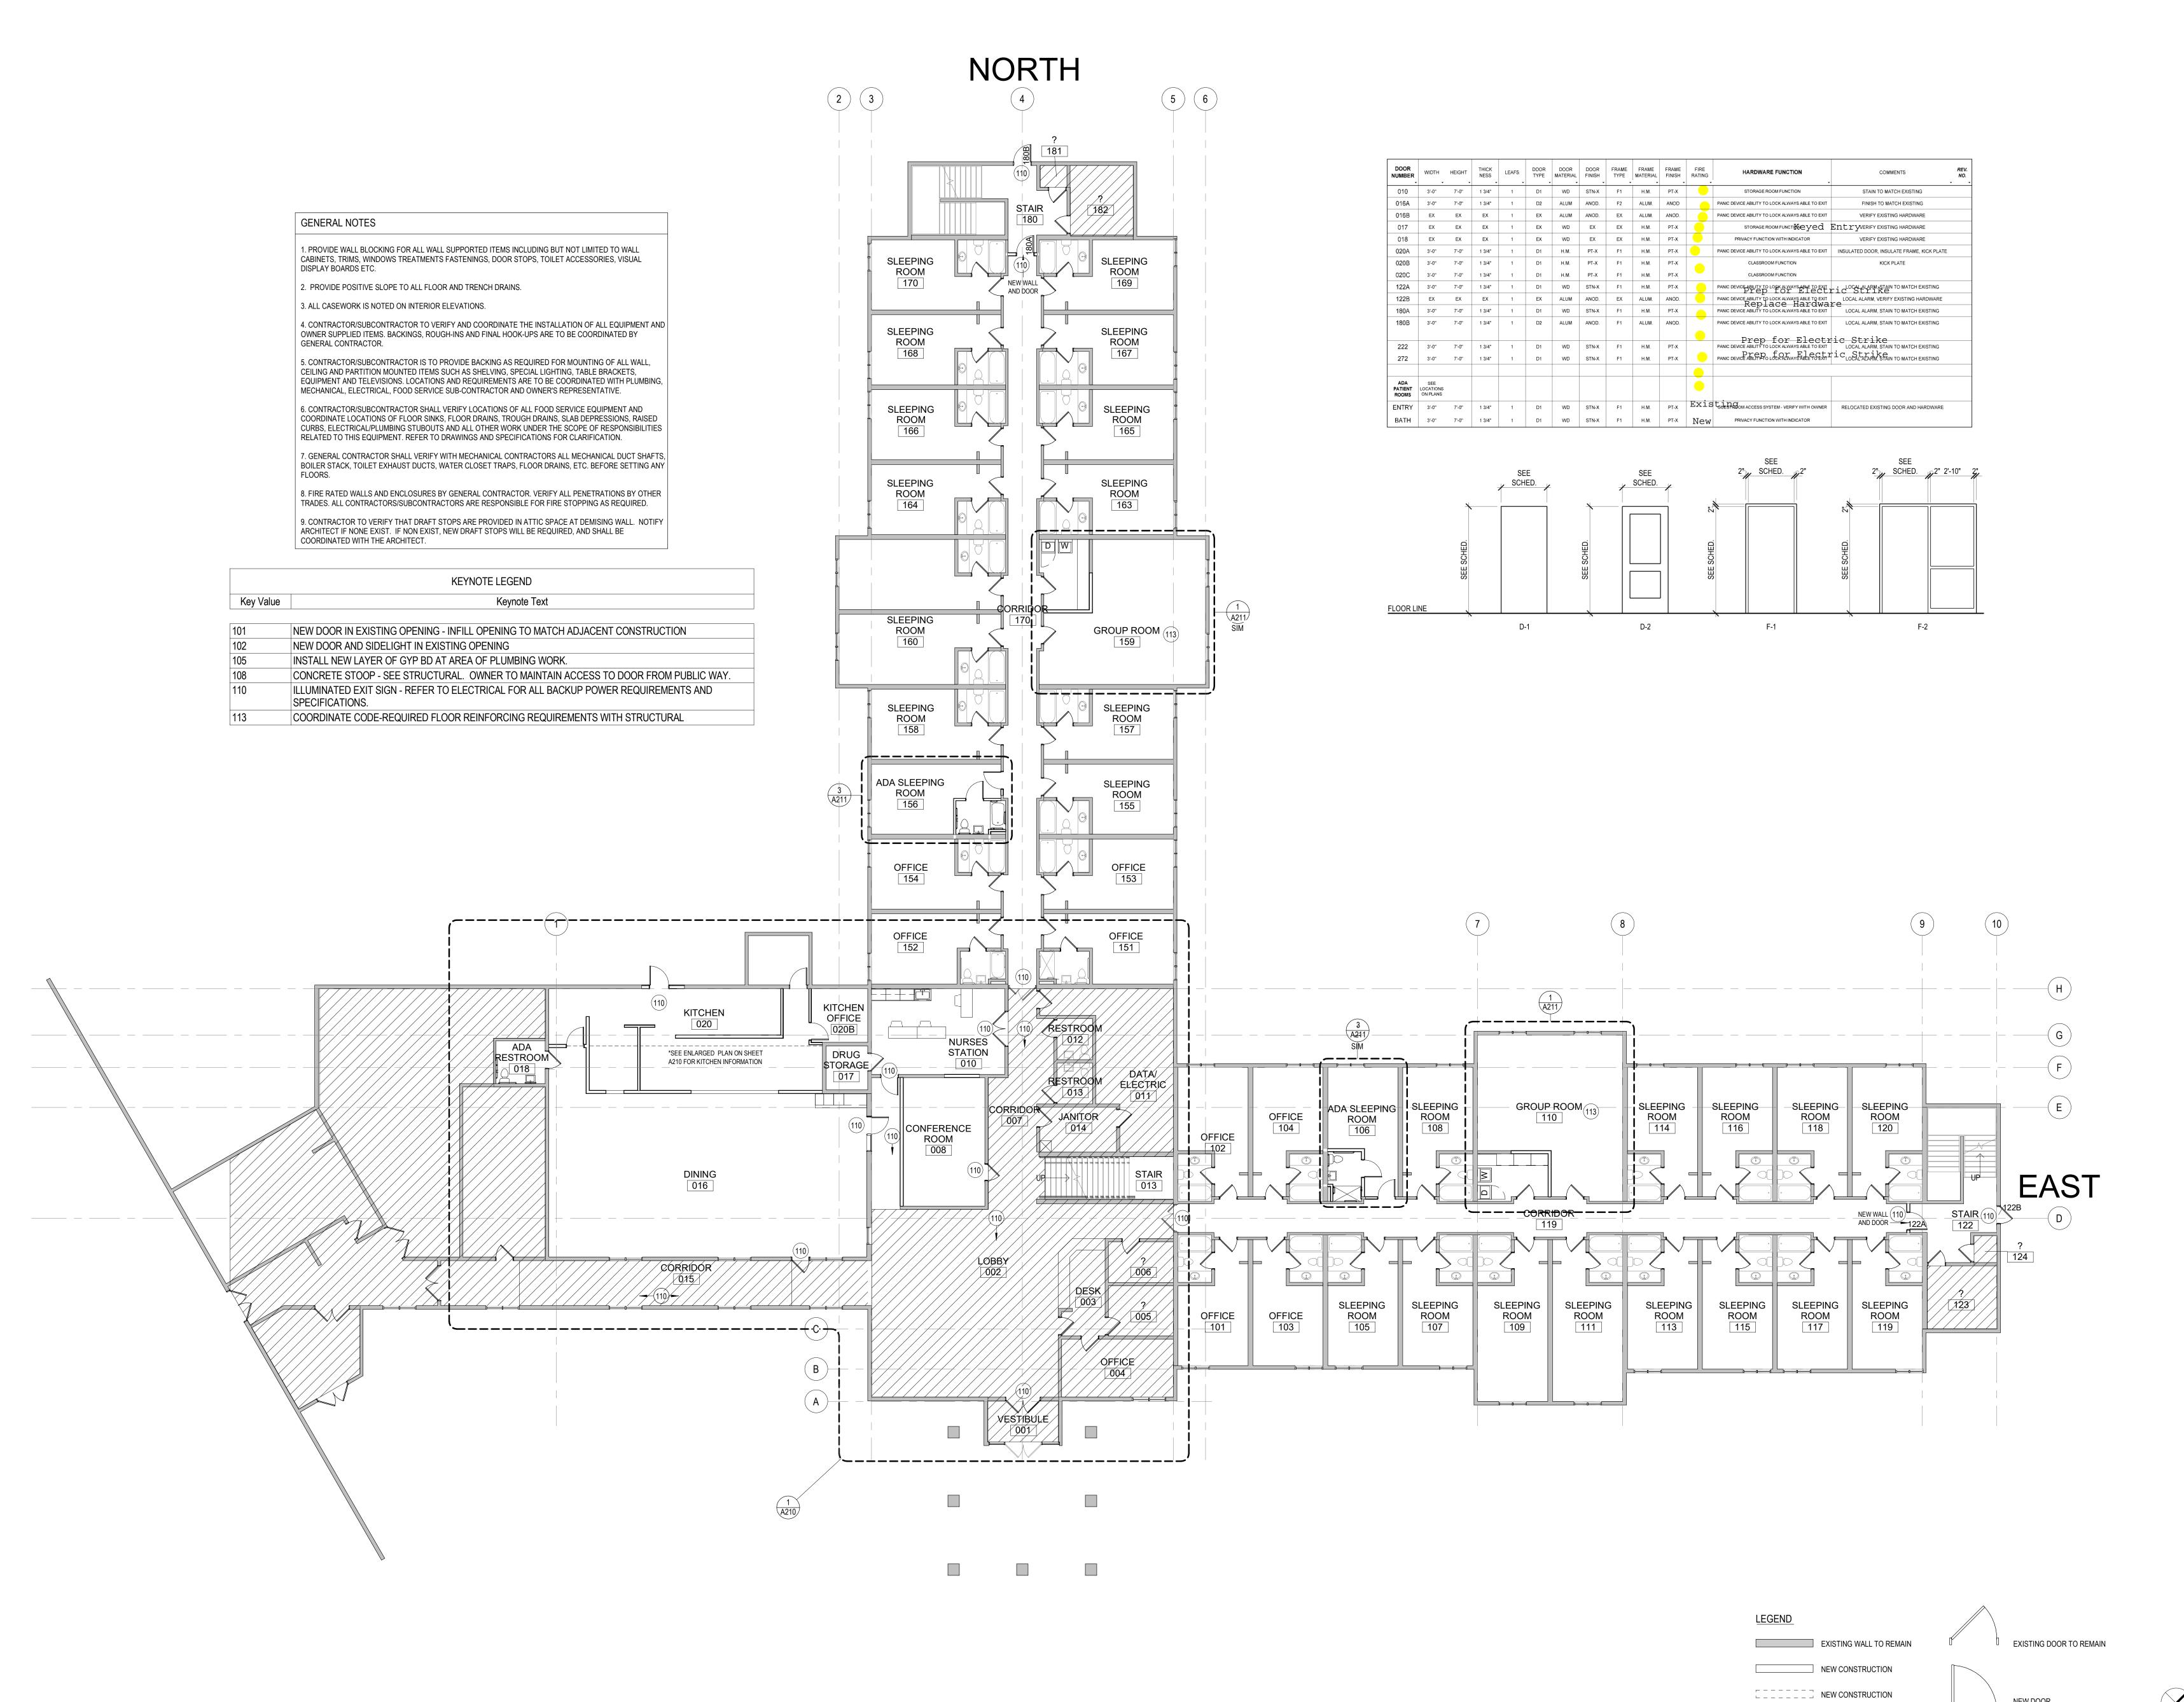
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CONSTRUCTION DOCUMENTS

LEVEL 2 OVERALL DEMOLITION FLOOR PLAN

20.1025.01 Drawing Number

Level 2 Demolition Floor Plan A102 3/32" = 1'-0"



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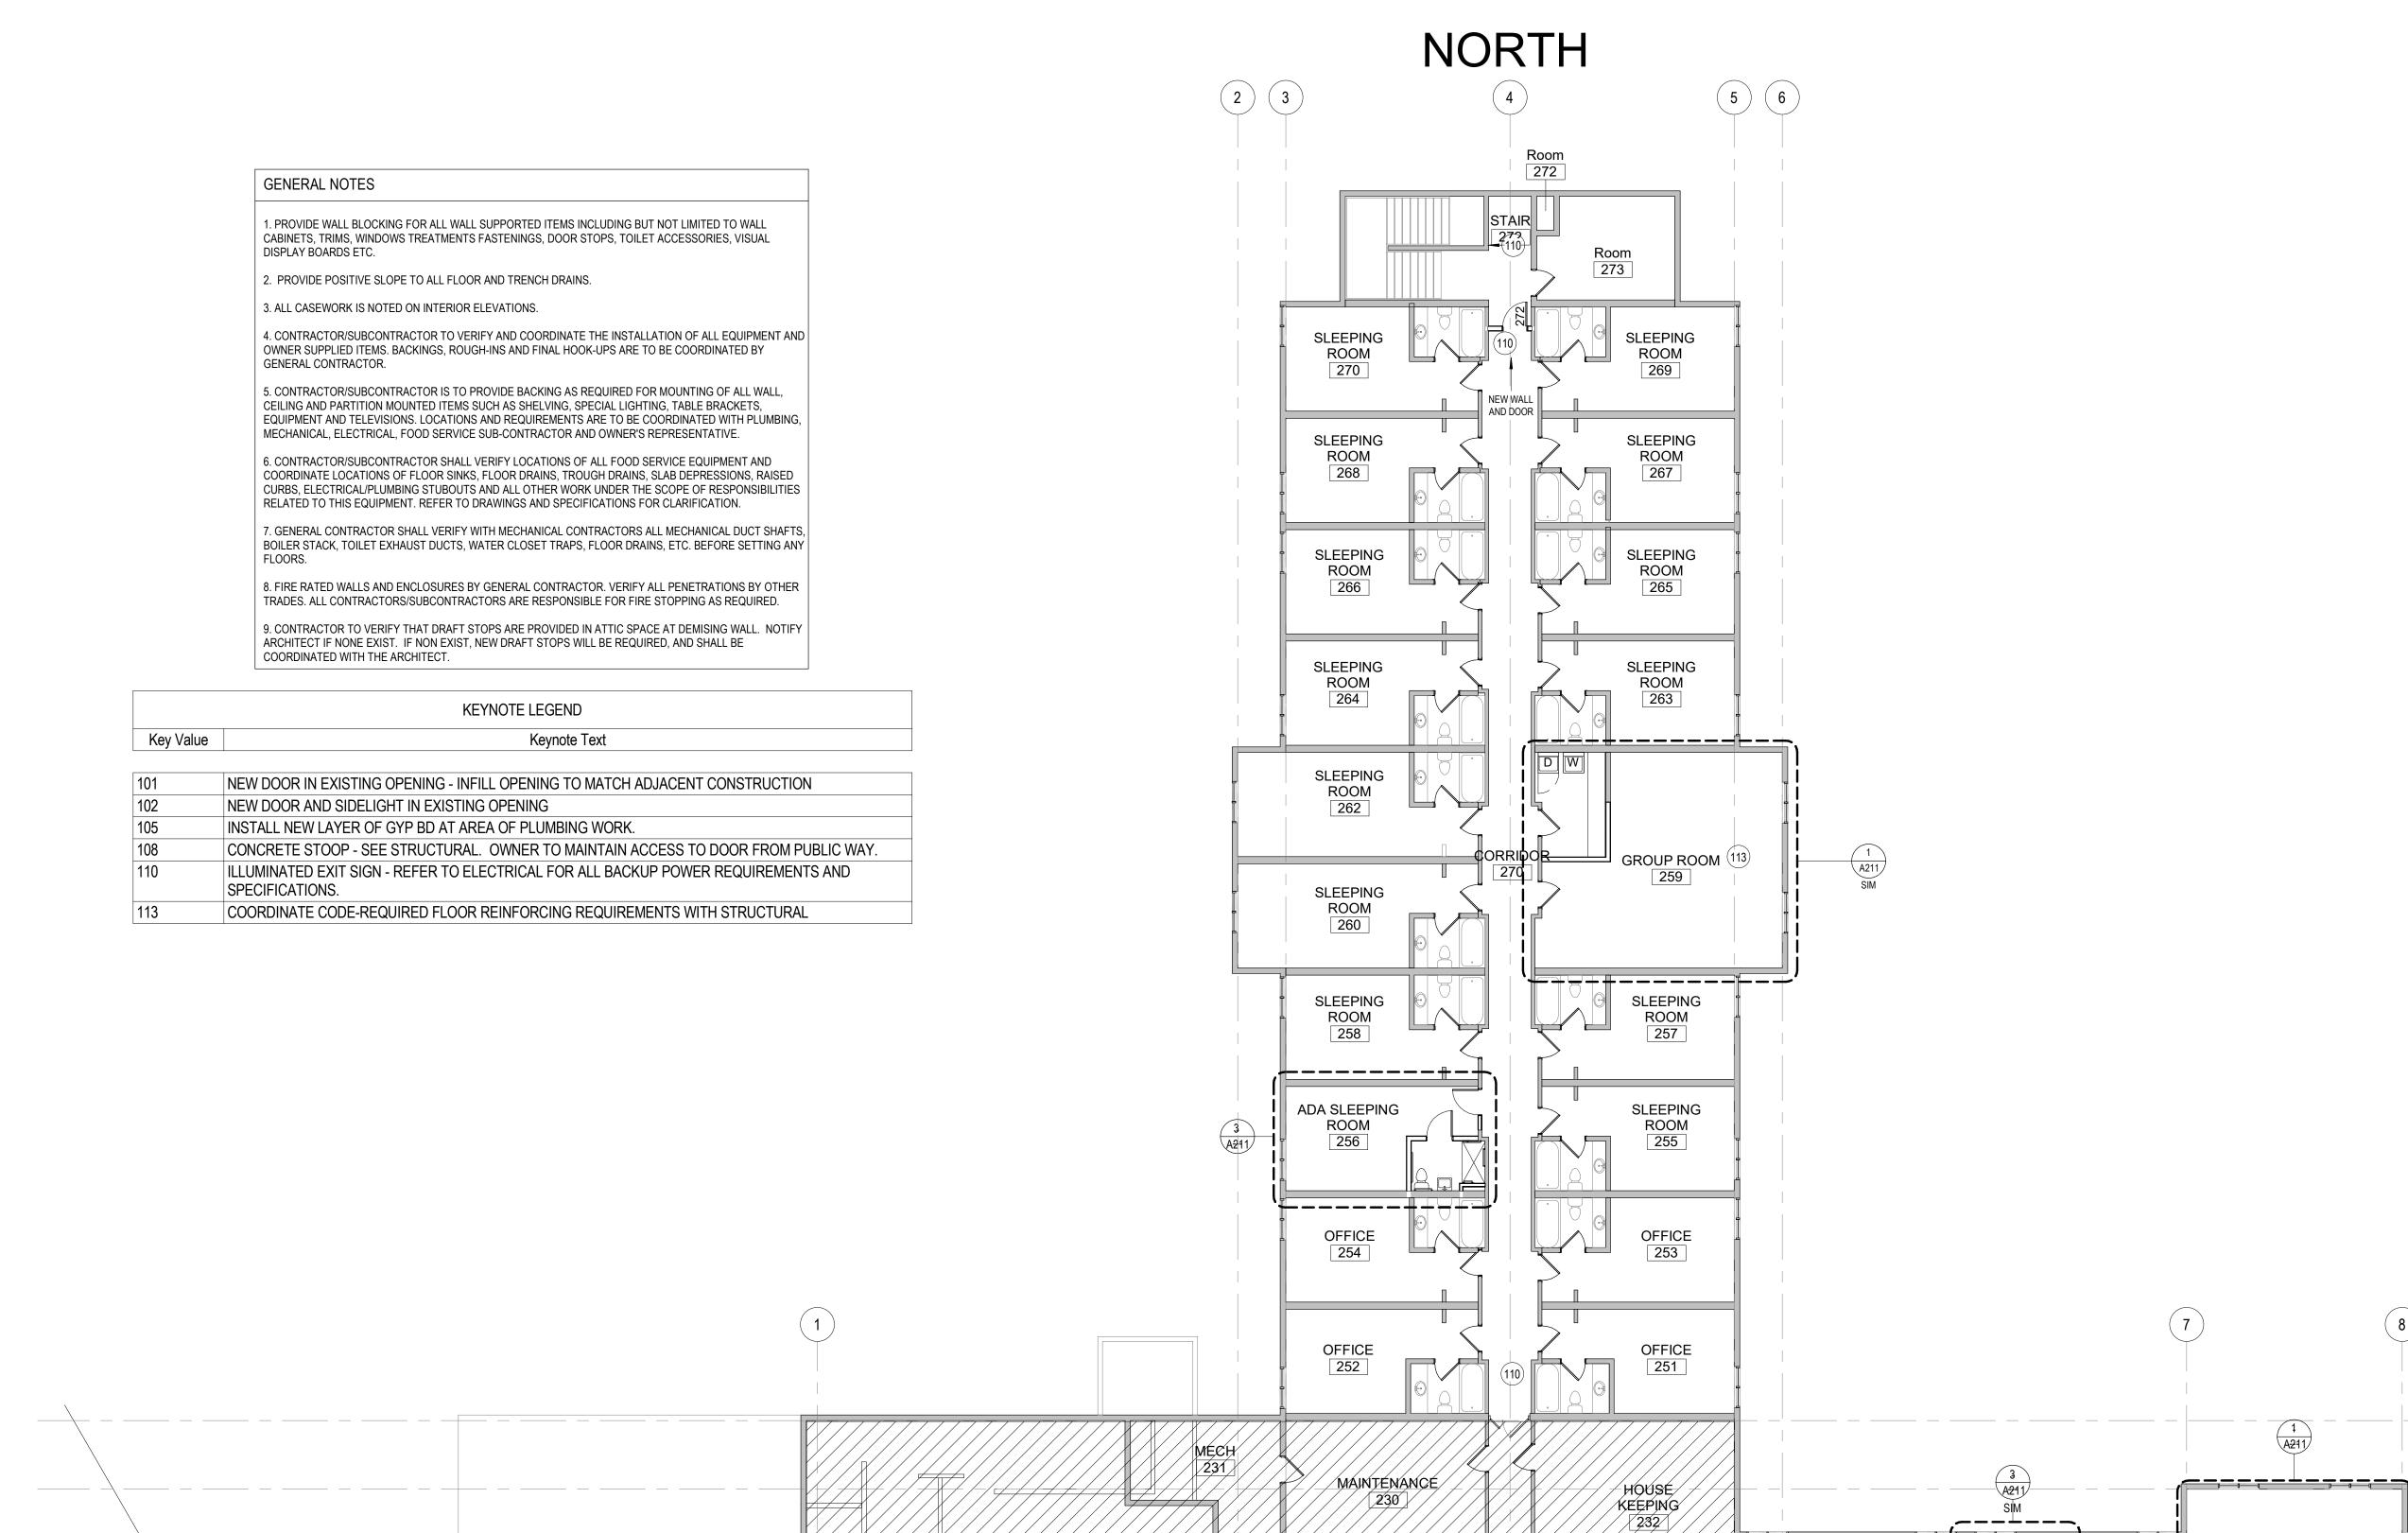
LEVEL 1 OVERALL FLOOR PLAN

20.1025.01 Drawing Number

1 Level 1 Floor Plan
3/32" = 1'-0"

NEW DOOR

NOT IN SCOPE



GAME ROOM/

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Date: 4.15.21 License #: 23884

No. Date Revision Description

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LEVEL 2 OVERALL FLOOR PLAN

Project 20.1025.01 Drawing Number

Date 1.15.21

LEGEND

EXISTING WALL TO REMAIN

NEW CONSTRUCTION

NEW CONSTRUCTION

NOT IN SCOPE

EXISTING DOOR TO REMAIN

NEW DOOR

NEW DOOR

SLEEPING ROOM 214

SLEEPING

ROOM 213

SLEEPING

ROOM 211

GROUP ROOM

SLEEPING

ROOM 209

ADA SLEEPING | SLEEPING

ROOM

SLEEPING

ROOM 207

ROOM 206

SLEEPING

ROOM 205

OFFICE 203

202

SLEEPING ROOM 218

SLEEPING

ROOM

SLEEPING

ROOM 216

SLEEPING


ROOM

SLEEPING ROOM

SLEEPING

ROOM

STAIR
222

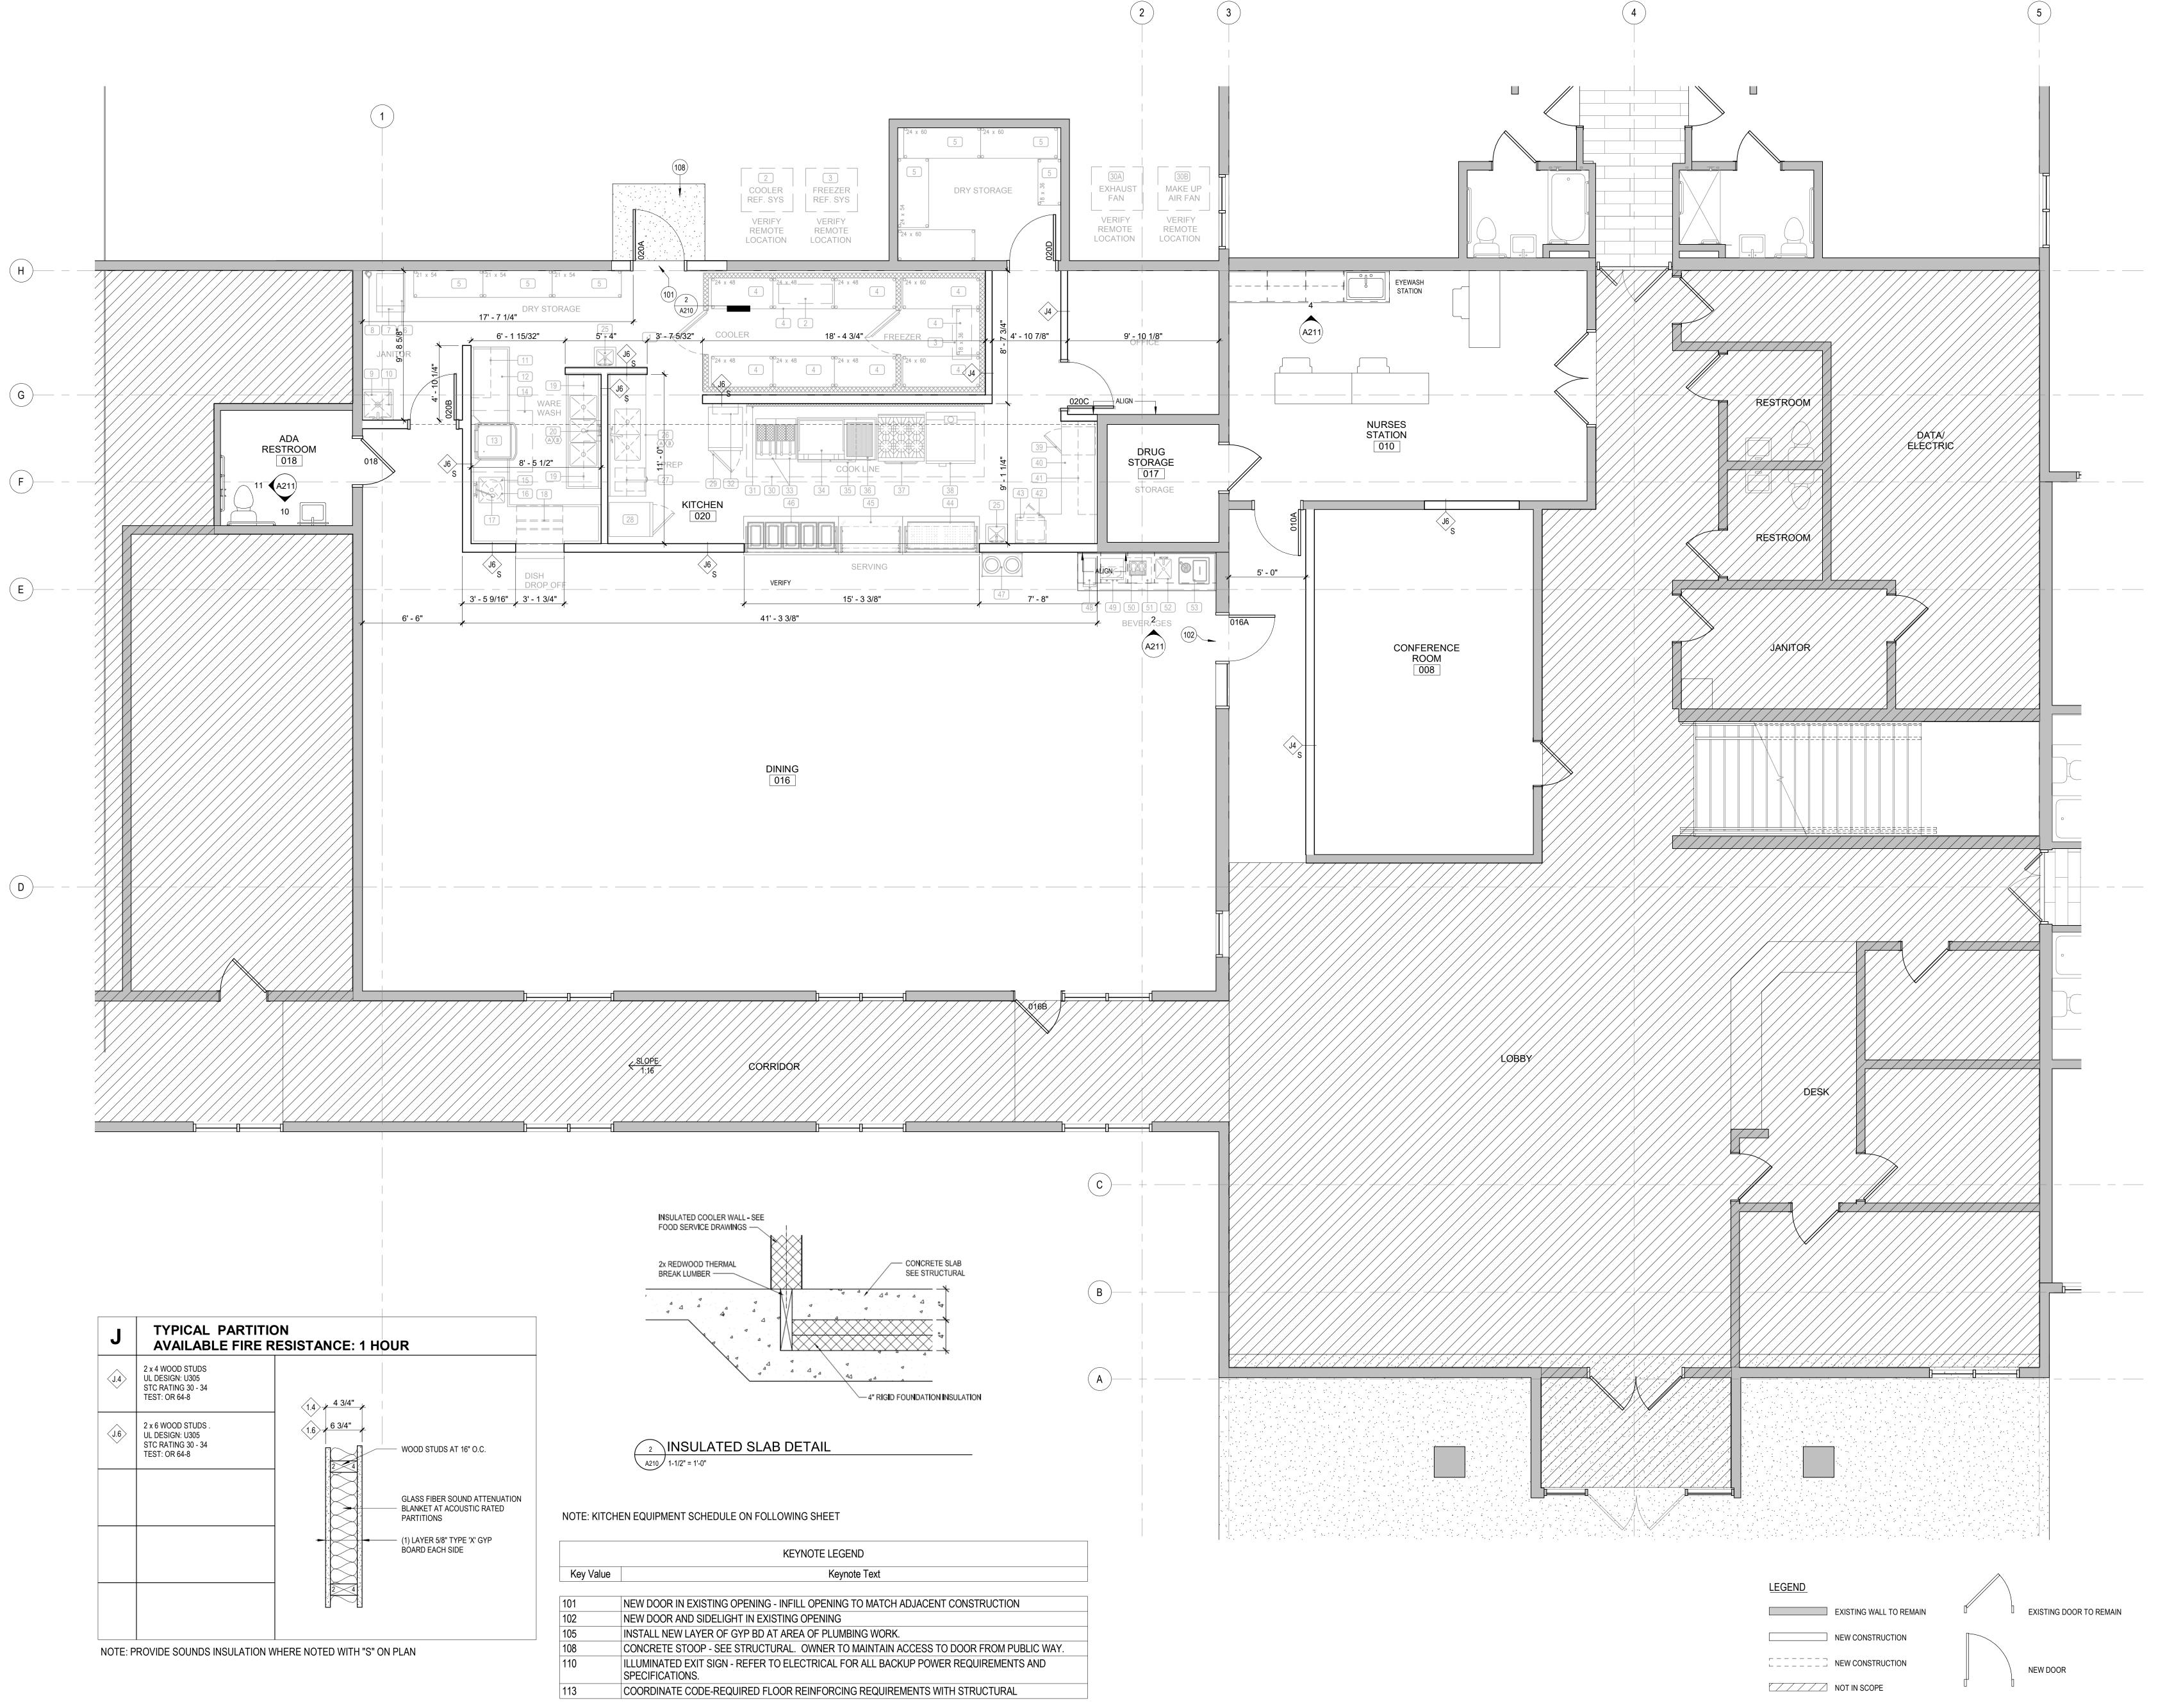

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Date: 4.15.21 License #: 2388

Date Revision Description

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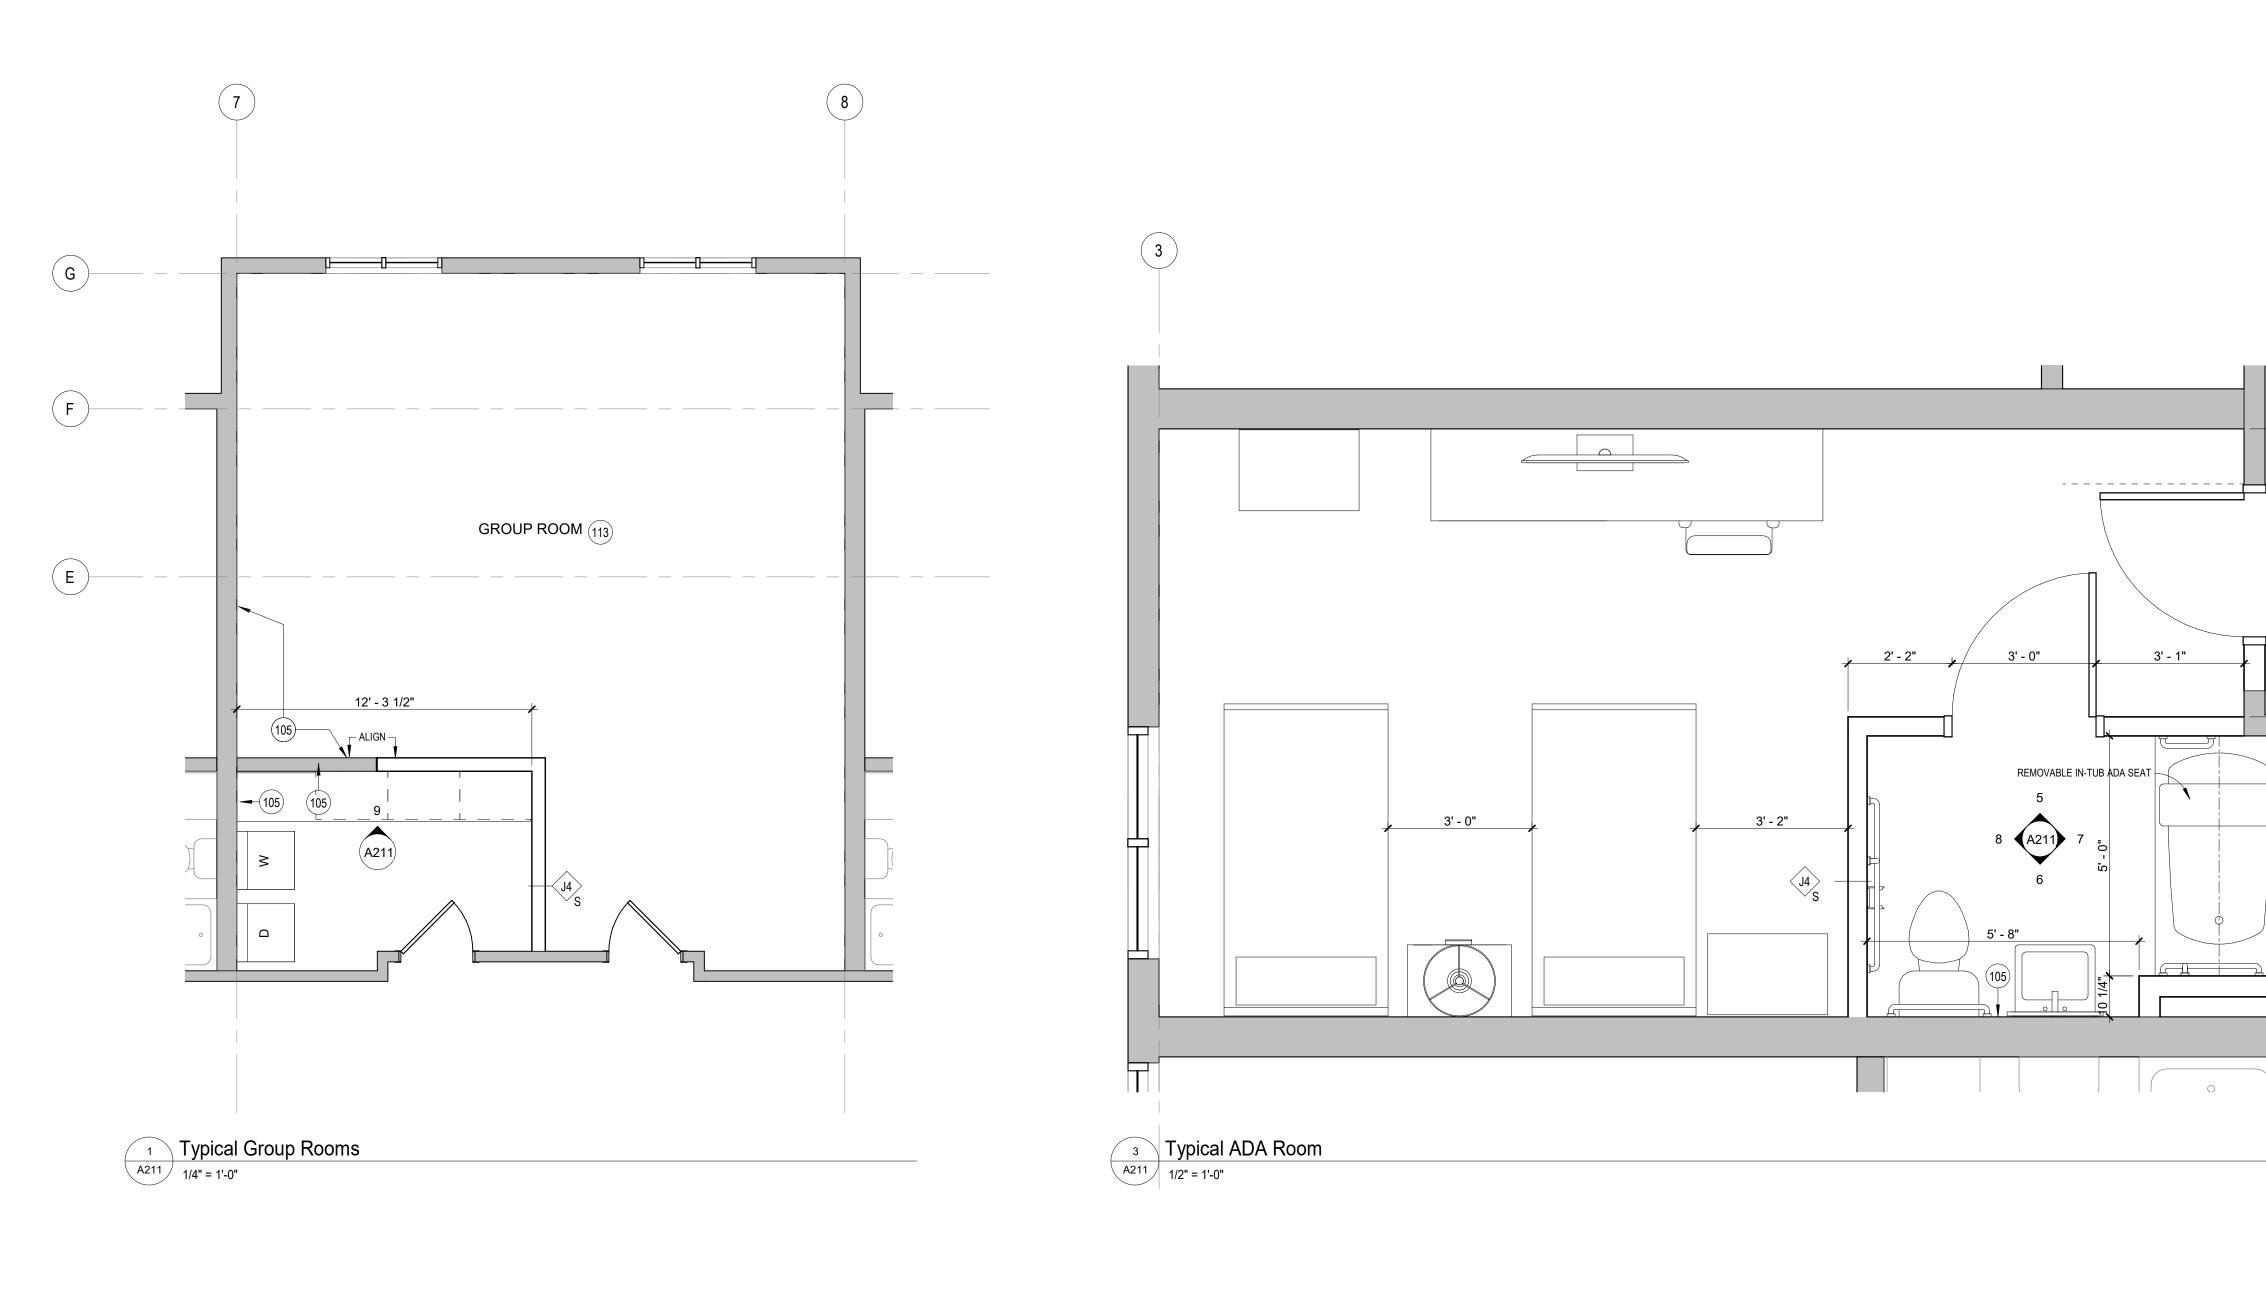
ENLARGED PLANS


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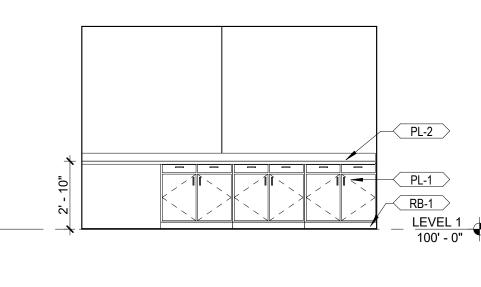
Date 1.15.21

NORTH


1 Cafeteria and Lobby
A210 1/4" = 1'-0"







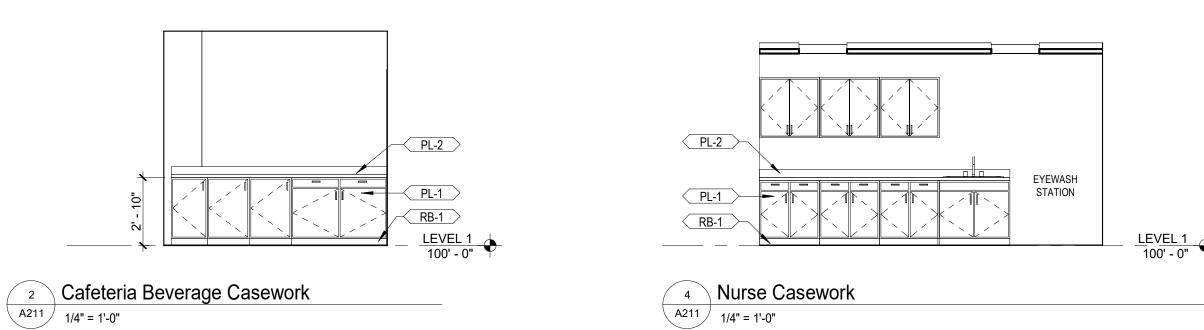



9 Laundry Room Casework Typical A211 1/4" = 1'-0"

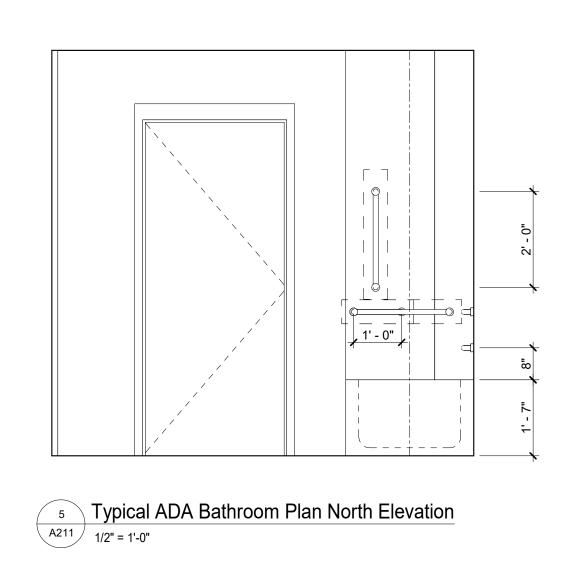

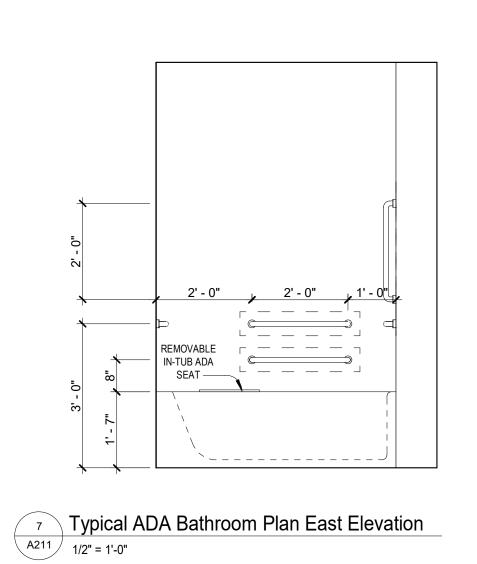


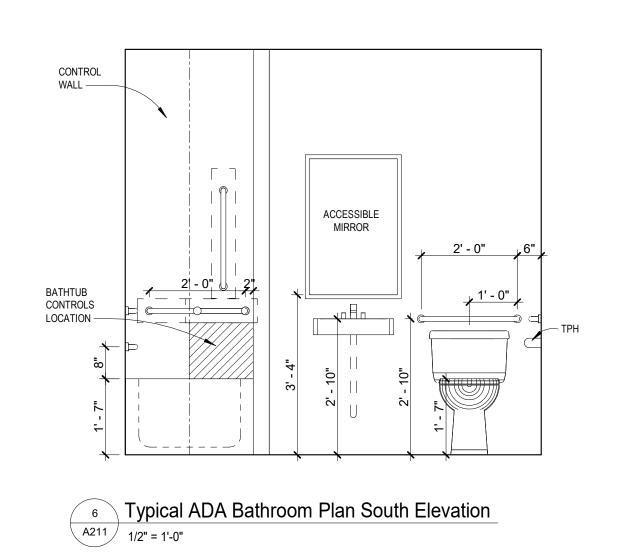

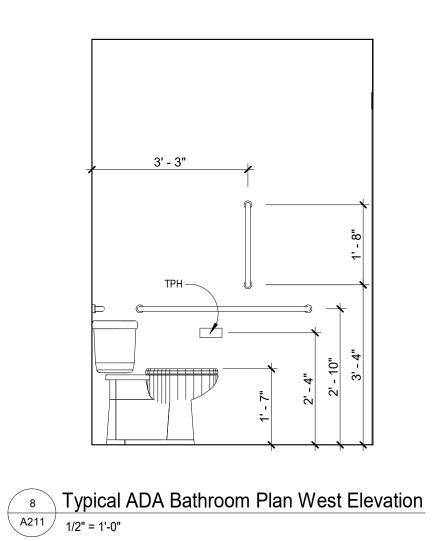

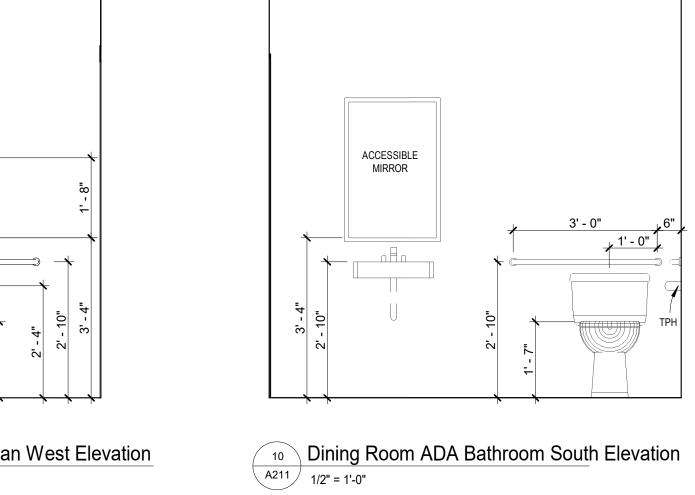

Key Value

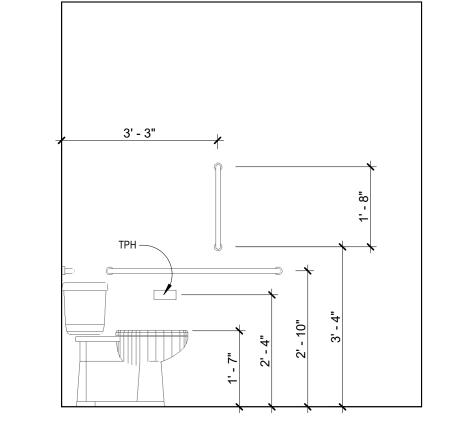

EXISTING DOOR TO REMAIN

NEW DOOR

KITCHEN EQUIPMENT SCHEDULE

REMARKS

VERIFY LOCATION
VERIFY LOCATION

BY OTHERS BY OTHERS

BY OTHERS BY OTHERS

KEYNOTE LEGEND

NEW DOOR IN EXISTING OPENING - INFILL OPENING TO MATCH ADJACENT CONSTRUCTION

CONCRETE STOOP - SEE STRUCTURAL. OWNER TO MAINTAIN ACCESS TO DOOR FROM PUBLIC WAY.

ILLUMINATED EXIT SIGN - REFER TO ELECTRICAL FOR ALL BACKUP POWER REQUIREMENTS AND

COORDINATE CODE-REQUIRED FLOOR REINFORCING REQUIREMENTS WITH STRUCTURAL

Keynote Text

NUM QTY DESCRIPTION

1 ICE BIN 1 WATER FILTER

MOP SINK

1 1 WALK IN COOLER-FREEZER
2 1 LOT COOLER REFRIGERATION SYSTEM
3 1 LOT FREEZER REFRIGERATION SYSTEM

4 1 LOT COOLER-FREEZER SHELVING
5 1 LOT DRY STORAGE SHELVING
6 1 ICE MACHINE

9 1 MOP SINK

10 1 CHEMICAL OVERSHELF

11 1 CLEAN DISHTABLE

12 1 SLANTED WALL SHELF

13 1 DISHWASHER

14 1 CONDENSTAE EXHAUST HOOD

15 1 DIRRTY DISHTABLE WITH SINK

16 1 DISPOSER

17 1 PRE-RINSE FAUCET

18 1 GLASS RACK SHELF

19 2 WALL MOUNT OVERSHELVES

19 2 WALL MOUNT OVERSHELVES
20 1 3 COMPARTMENT SINK

OPEN NUMBER OPEN NUMBER

OPEN NUMBER

OPEN NUMBER

27 1 WALL MOUNT OVERSHELF
28 1 REACH IN REFRIGERATIR

29 1 REACH IN FREEZER
30 1 EXHAUST HOOD
A 1 EXHAUST FAN

38 1 CONVECTION OVEN

WALL MOUNT HAND SINKS

B 1 MAKE UP AIR FAN

31 1 LOT FIRE SUPPRESSION SYSTEM

32 1 LOT INSULATED S/S WALL PANELS & TRIM

33 2 FRYERS

34 1 COUNTERTOP GRIDDLE

35 1 REFRIGERATED EQUIPMENT STAND

36 1 COUNTERTOP CHARBROILER 37 1 6 BURNER RANGE WITH OVEN

 38
 1
 CONVECTION OVEN

 39
 1
 UNDERCOUNTER HOT HOLDING CABINET

 40
 1
 WORK TABLE

 41
 1
 WALL MOUNT OVERSHELF

 42
 1
 MICROWAVE OVEN

 43
 1
 MICROWAVE SHELF

 44
 1
 COLD SERVING COUNTER

 45
 1
 SERVING COUNTER

 46
 1
 HOT SERVING COUNTER

 47
 1
 PLATE CART

 48
 1
 ICE TEA BREWER

 49
 1
 AIR POT COFFEE BREWER

 50
 1
 AIR POT STAND

 51
 1 LOT GLASS RACKS

 52
 1
 BEVERAGE COUNTER WITH SINK

 53
 1
 ICE AND WATER DISPENSER

 54
 OPEN NUMBER

 55
 OPEN NUMBER

NEW DOOR AND SIDELIGHT IN EXISTING OPENING

<u>LEGEND</u>

SPECIFICATIONS.

INSTALL NEW LAYER OF GYP BD AT AREA OF PLUMBING WORK.

EXISTING WALL TO REMAIN

NEW CONSTRUCTION

_____ NEW CONSTRUCTION

NOT IN SCOPE

PREP TABLE WITH 2 COMP SINK

A 1 PRE-RINSE FAUCET

B 1 FILL FAUCET

Dining Room ADA Bathroom West Elevation

11
A211
1/2" = 1'-0"

ARCHITECTS

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Quintin J. Scott, AIA

Date: 4.15.21 License #: 23884


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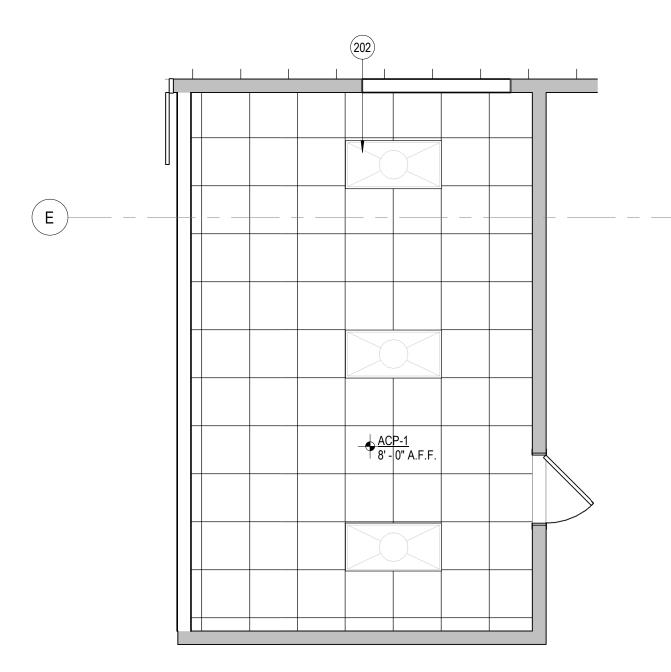
CONSTRUCTION DOCUMENTS

ENLARGED PLANS CONT. & INTERIOR **ELEVATIONS**

20.1025.01 Drawing Number Checked by

NORTH




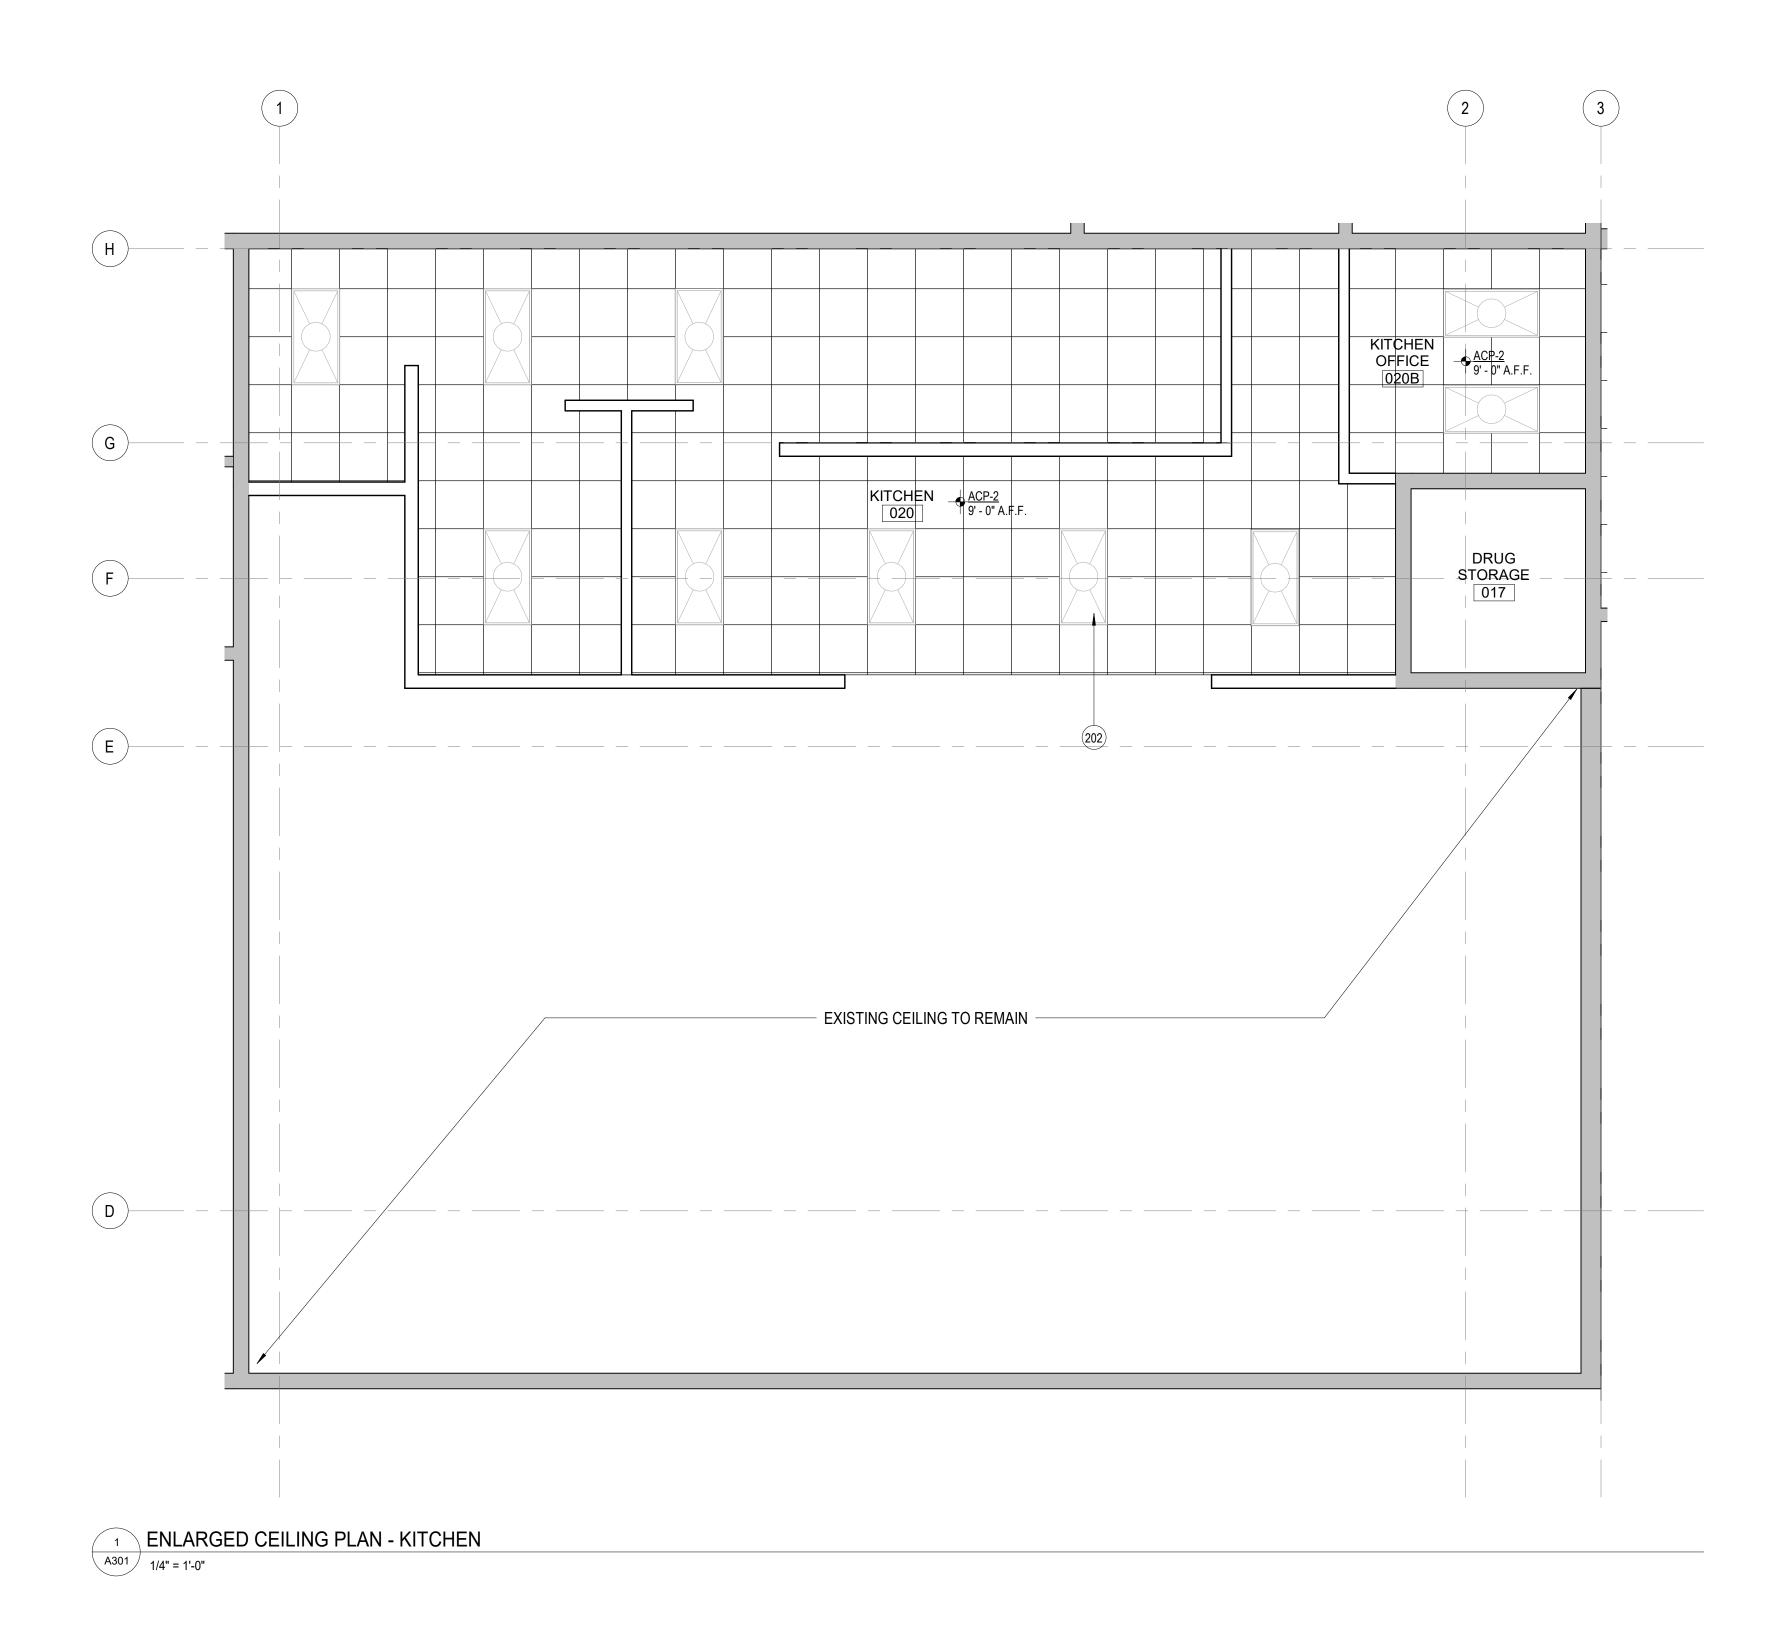


2 ENLARGED CEILING PLAN - CONFERENCE ROOM

1/4" = 1'-0"

3 ENLARGED CEILING PLAN - NURSE
1/4" = 1'-0"

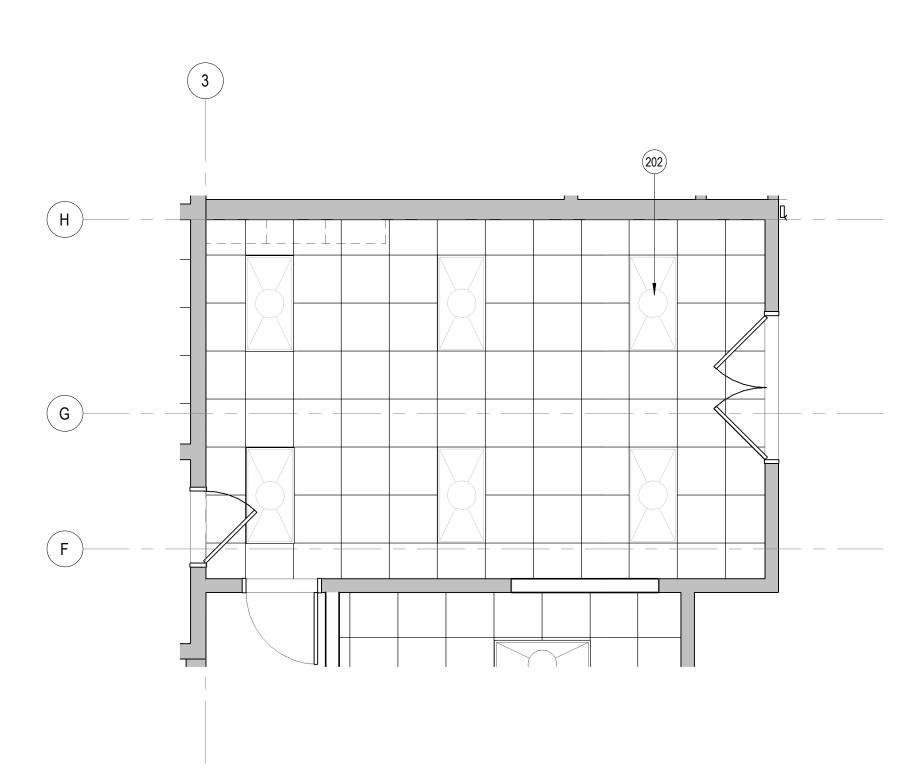

| | RCP KEYNOTE LEGEND |
|-----------|---|
| Key Value | Keynote Text |
| 202 | LIGHTING BY ELECTRICAL - REFER TO ELECTRICAL DRAWINGS FOR EXACT LOCATIONS, FIXTURE TYPES, AND SPECIFICATIONS. |

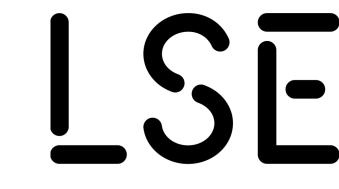

ARCHITECTS
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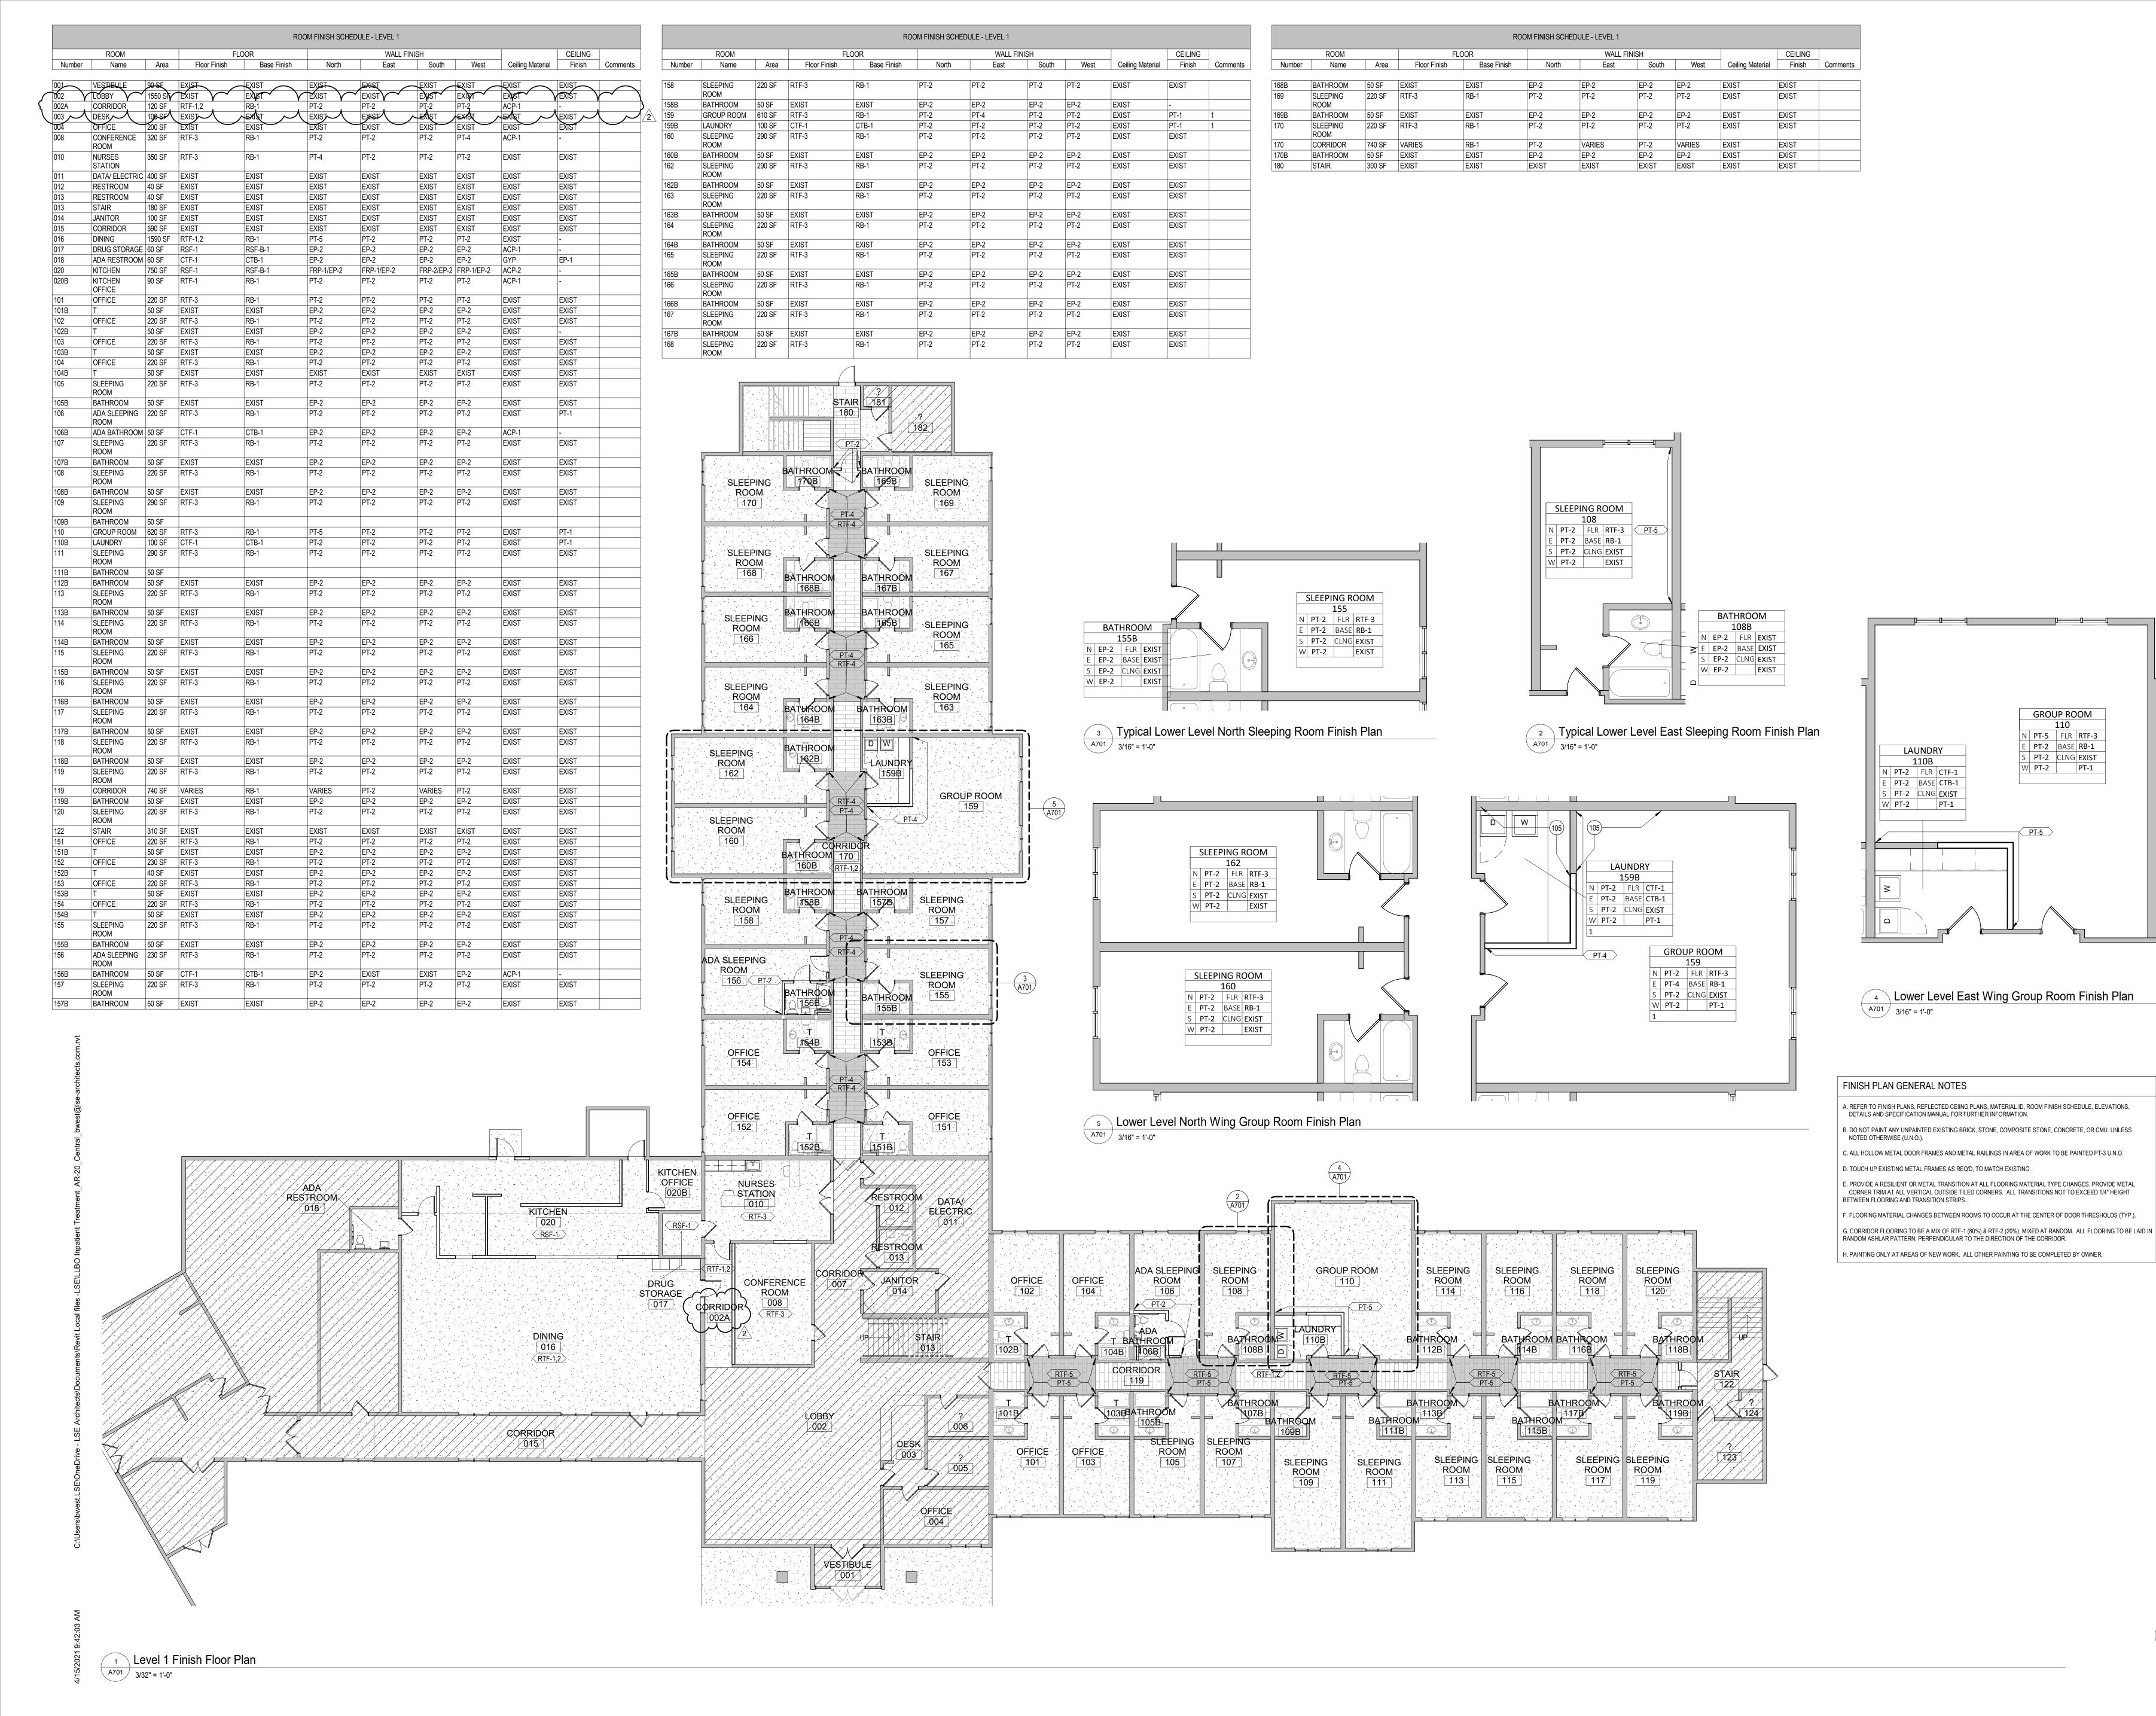
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ENLARGED CEILING PLANS

Project 20.1025.01 Drawing Number

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KRAUS-ANDERSON_®

GROUP ROOM

N PT-5 FLR RTF-3

E PT-2 BASE RB-1

S PT-2 CLNG EXIST

W PT-2 PT-1

PT-5

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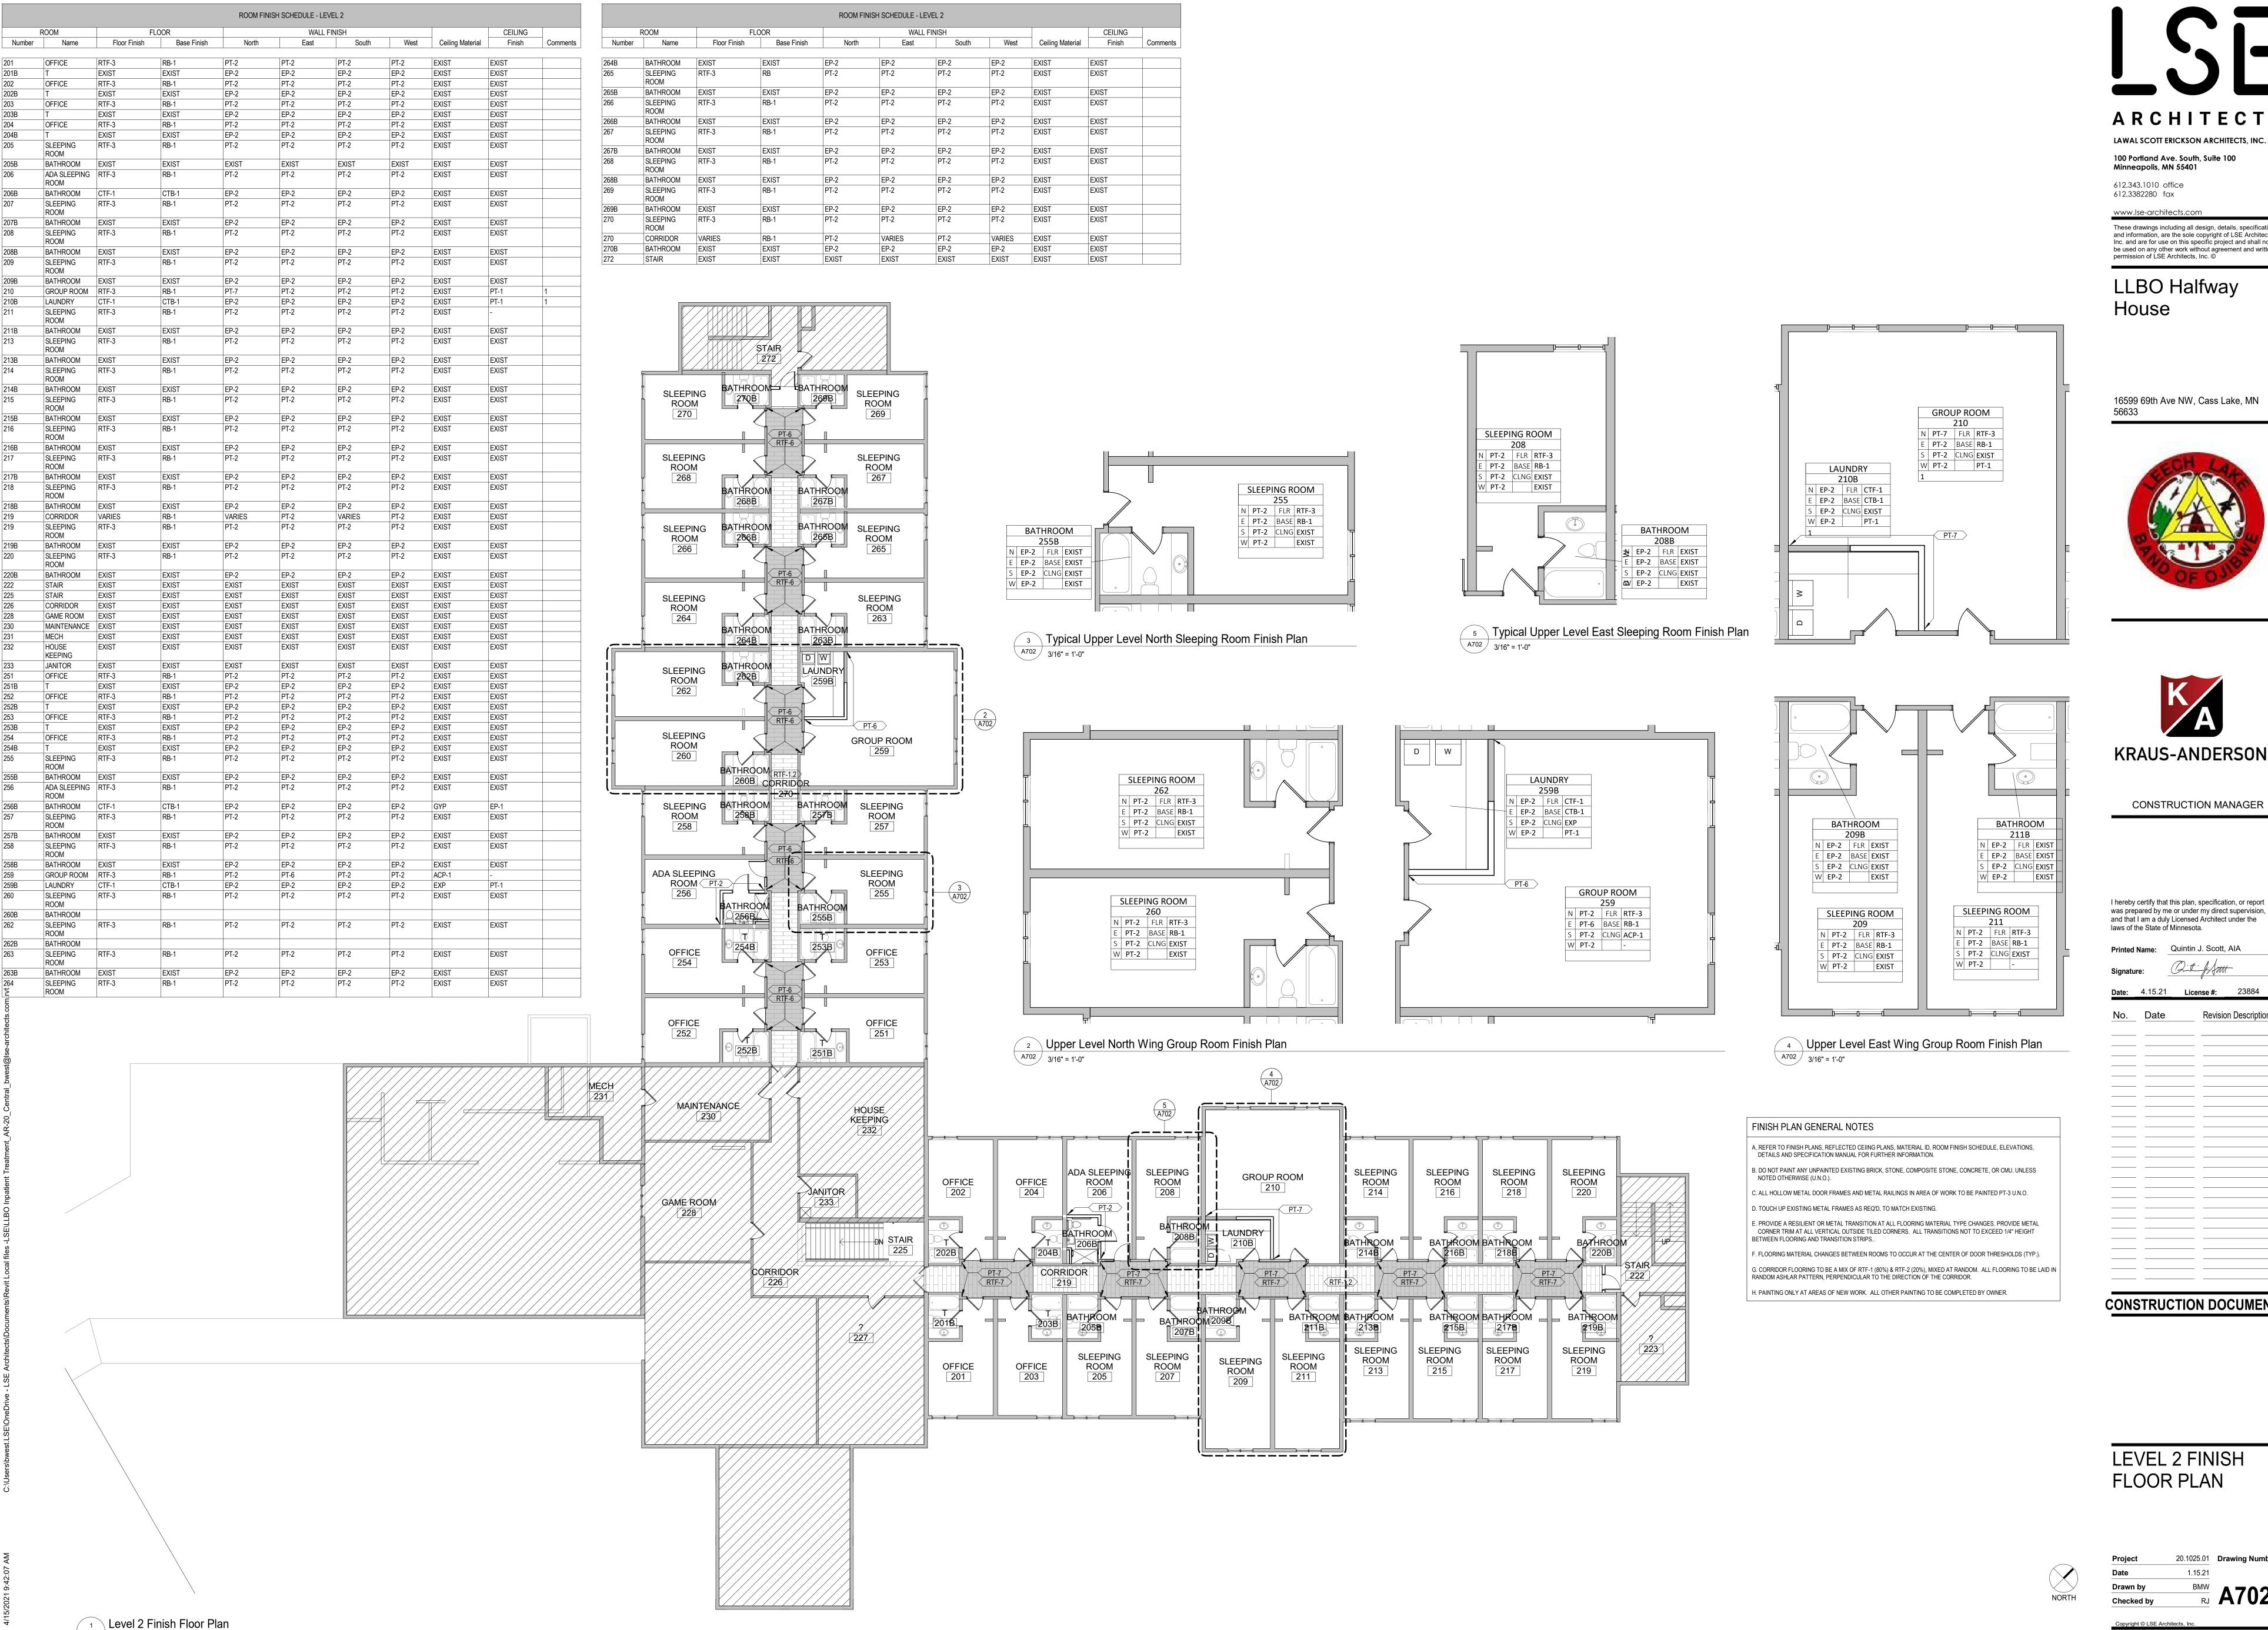
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LEVEL 1 FINISH FLOOR PLAN

20.1025.01 Drawing Number



A702 3/32" = 1'-0"

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LEVEL 2 FINISH FLOOR PLAN

| MATER | IAI ID | - INTFF | RIOR FIN | NISH & MATERIAL SCHEDULE | | |
|---|----------|----------------------|----------------|--|--|-------------------------------|
| GROUP NAME | REVISION | SECTION | MATERIAL ID | | NOTES | LOCATION |
| ACOUSTICAL CEILING PANELS ACOUSTICAL CEILING PANELS | | | T | USG, ASTRO CLIMAPLUS, FLB, 2 X 2 X 5/8", # 8227, COLOR: WHITE, EDGE: SQUARE. NRC: .80, CAC: 40, | | |
| ACOUSTICAL CEILING PANELS | | | ACP-1 | GRID: DONN DX 15/16", COLOR: WHITE. USG, KITCHEN LAY-IN PANELS 3210, SIZE: 2' x2' x 5/8", COLOR: WHITE, EDGE: SQUARE, CAC: 35, GRID: | | |
| | | | AUF-2 | DONN DX 15/16", COLOR: WHITE. | | |
| CTB - CERAMIC TILE BASE CTB - CERAMIC TILE BASE | | 09 30 00 | CTB-1 | TILE BY DESIGN, FLORIM, STYLE: STONEFIRE 1093347, COLOR: ALMOND, SIZE: 3" x 12" | ALIGN GROUT LINES FROM FLOOR TO WALL | |
| CTF - CERAMIC TILE FLOOR | | | | | PLOOR TO WALL | |
| CTF - CERAMIC TILE FLOOR | | 09 30 00 | CTF-1 | TILE BY DESIGN, FLORIM, STYLE: STONEFIRE 1093342, COLOR: ALMOND, SIZE: 12" x 12" | ALIGN GROUT LINES FROM FLOOR TO WALL | |
| EPOXY PAINT | | | | | | |
| EPOXY PAINT EPOXY PAINT | | 09 91 00 09 91 00 | EP-1 EP-2 | EPOXY PAINT, SEMI-GLOSS FINISH, TO MATCH: PT-1. EPOXY PAINT, SEMI-GLOSS FINISH, TO MATCH: PT-2. | | |
| FRP - FIBERGLASS REINFORCED PANELS | | 20.00.40 | T | WELFULTE OR FOLINAL ENT EIREROL AGO REINFORGER RANEL TENTURE REPRINER AGO OR MAINTE | | |
| FRP - FIBERGLASS REINFORCED PANELS | | 06 83 16 | FRP-1 | KEMLITE OR EQUIVALENT, FIBERGLASS REINFORCED PANEL, TEXTURE: PEBBLED, COLOR: WHITE; PROVIDE MATCHING TRIM | | |
| GR - GROUT GR - GROUT | | 09 30 00 | GR-1 | MAPEI, COLOR: 105 DRIFTWOOD | | |
| MT - METAL TRIM | | 100000 | Ţ, Ç, X, | | | |
| MT - METAL TRIM | | 09 30 00 | MT-1 | SCHLUTER SYSTEMS, STYLE: RENO-V, FINISH: SATIN ANODIZED ALUMINUM | | FLOOR TRANSITIONS |
| PL - PLASTIC LAMINATE | | I | | | | I |
| PL - PLASTIC LAMINATE | | 06 40 23 06 40 23 | PL-1 PL-2 | FORMICA, WEATHERED FIBERWOOD 8914-58 FORMICA, WHITE TWILL 9285-58 | | VERTICAL CASEWORK |
| PT - PAINT | | 00 40 23 | PL-Z | FORMICA, WHITE TWILL 9285-58 | | DRY COUNTERS |
| PT - PAINT PT - PAINT | | 09 91 00 09 91 00 | PT-1 | SHERWIN WILLIAMS, COLOR: SW7627 WHITE HERON SHERWIN WILLIAMS, COLOR: SW9588 HIGH SIERRA | | CEILING WHITE |
| PT - PAINT | | 09 91 00 | PT-2 | SHERWIN WILLIAMS, COLOR: SW7048 URBANE BRONZE | | NEUTRAL MISC METALS |
| PT - PAINT | | 09 91 00 | PT-4 | SHERWIN WILLIAMS, COLOR: SW6207 RETREAT | | ACCENT - 1ST FLOOR N |
| PT - PAINT | | 09 91 00 | PT-5 | SHERWIN WILLIAMS, COLOR: SW6212 QUIETUDE | | ACCENT - 1ST FLOOR E |
| PT - PAINT | | 09 91 00 | PT-6 | SHERWIN WILLIAMS, COLOR: SW7618 DEEP SEA DIVE | | ACCENT - 2ND |
| PT - PAINT | | 09 91 00 | PT-7 | SHERWIN WILLIAMS, COLOR: SW7602 INDIGO BATIK | | FLOOR N ACCENT - 2ND FLOOR E |
| RB - RESILIENT BASE | | | | | | |
| RB - RESILIENT BASE | | 09 65 13 | RB-1 | 4"H VINYL BASE, JOHNSONITE, COLOR: 39 MOON ROCK | STRAIGHT AT CARPET, COVE AT HARD SURFACE. COILS ONLY | D |
| RTS - RESILIENT TRANSITION STRIP | | | | | ONLT | |
| RTS - RESILIENT TRANSITION STRIP | | 09 65 13 | RTS-1 | JOHNSONITE, CTA-39-A, COLOR: 39 MOON ROCK | | |
| RTS - RESILIENT TRANSITION STRIP | | 09 65 13 | RTS-2 | JOHNSONITE, CTA-39-J, COLOR: 39 MOON ROCK | | |
| RESILIENT SHEET FLOORING RESILIENT SHEET FLOORING | | | RSF-1 | ECO GRIP, COLOR: PEWTER, W/ INTEGRAL WALL BASE, 6"H (SEE RSF-B) | | KITCHEN |
| RESILIENT SHEET FLOORING BASE RESILIENT SHEET FLOORING BASE | | | RSF-B-1 | ECO GRIP, COLOR: PEWTER, 6"H INTEGRAL WALL BASE W/ MATCHING VINYL TOP CAP | | KITCHEN |
| RESILIENT TILE FLOORING | | | KOF-D-1 | ECO GRIP, COLOR. PEWTER, 6 H INTEGRAL WALL BASE W/ MATCHING VINTL TOP CAP | | KITCHEN |
| RESILIENT TILE FLOORING | | | RTF-1 | INTERFACE, BRUSHED LINES LVT A016, COLOR: A01609 PARAFFIN, SIZE: 25CM x 1M | | |
| RESILIENT TILE FLOORING RESILIENT TILE FLOORING | | | RTF-2 RTF-3 | INTERFACE, BRUSHED LINES LVT A016, COLOR: A01611 MOUSSE, SIZE: 25CM x 1M INTERFACE. STUDIO SET LVT A007, COLOR: A00705 TITANIUM. SIZE: 25CM x 1M | | |
| RESILIENT TILE FLOORING | | | RTF-4 | INTERFACE, BRUSHED LINES LVT A016, COLOR: A01619 EUCALYPTUS, SIZE: 25CM x 1M | | |
| RESILIENT TILE FLOORING RESILIENT TILE FLOORING | | | RTF-5 RTF-6 | INTERFACE, BRUSHED LINES LVT A016, COLOR: A01618 CELADON, SIZE: 25CM x 1M INTERFACE, BRUSHED LINES LVT A016, COLOR: A01620 TEAL OXIDE, SIZE: 25CM x 1M | | |
| RESILIENT TILE FLOORING | | | RTF-7 | INTERFACE, BRUSHED LINES LVT A016, COLOR: A01622 DEEP COBALT, SIZE: 25CM x 1M | | |
| TOILET ACCESSORIES | | | | | | |
| TOILET ACCESSORIES | | | TA-1 | BOBRICK, B-69997 SURFACE-MOUNTED DOUBLE-ROLL TOILET TISSUE DISPENSER W/ HOODS, FINISH: BRUSHED STAINLESS STEEL, SIZE: 12-3/8"W x 6-3/16"H x 4-3/4"D. | : | |
| TOILET ACCESSORIES | | | TA-2 | BOBRICK, B-37063, TRIMLINE SERIES RECESSED NAPKIN/TAMPON VENDOR | | |
| TOILET ACCESSORIES TOILET ACCESSORIES | | | TA-3 TA-4 | BOBRICK, B-270, CONTURA SERIES SURFACE MOUNTED FEMININE NAPKIN DISPOSAL WASTE RECEPTACLES | | |
| TOILET ACCESSORIES TOILET ACCESSORIES | | | TA-4 | TOILET MIRROR - 1/4" STAINLESS STEEL BRUSHED FRAME, BOBRICK #B-290, REFER TO DWGS FOR | | |
| TOILET ACCESSORIES | | | TA-5 | DIMENSIONS, REFER TO PROJECT MANUAL FOR SPECIFICATIONS PAPER TOWEL DISPENSER | | |
| TOILET ACCESSORIES | | | TA-7 | AMERICAN HOTEL REGISTER CO, HOOKLESS LITCHFIELD SHOWER CURTAIN, 3x6 WHITE. | | |
| TOILET ACCESSORIES | | | TA-8 | #2240LITCHFIELDS-WHT. 42"W x 74"L. 100% POLYESTER, MACHINE WASHABLE BOBRICK, B-5181, REVERSIBLE SOLID PHENOLIC FOLDING SHOWER SEAT. MATTE FINISH, COLOR: | | |
| TOILET ACCESSORIES | | | | IVORY. STAINLESS STEEL FRAME W/ SATIN FINISH, 16 GAUGE. 33"W x 14-7/16"D SEAT. BOBRICK, B-6107, HEAVY-DUTY SHOWER CURTAIN ROD W/ CONCEALED MOUNTING. 20 GAUGE | | |
| TOILET ACCESSORIES | | | TA-9 | STAINLESS STEEL TUBING W/ SATIN FINISH. 36"W x 1-3/8"DIA. BOBRICK, B-6806.99 SERIES, 1-1/2"DIA. STAINLESS STEEL GRAB BARS W/ SNAP FLANGE AND PEENED | | |
| | | | TA-10 | GRIPPING SURFACE. REFER TO DETAIL 1/A60 FOR GRAB BAR DIMENSIONS. | | |

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Signature: Quintin J. Scott, Al.

Date: 4.15.21 License #: 23884

No. Date Revision Description

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MATERIAL ID

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Date 1.15.21

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